





# BEAVER LAKE INDUSTRIAL - BUILDING 7

334 BEAVER LAKE ROAD KELOWNA, BC V4V 1S7

### SHEET LIST

ARCHITECTURE A0.00

A0.01 PERSPECTIVES A0.10 GENERAL CONDITIONS

BUILDING CODE REVIEW & FIRE SEPARATION A0.20 PLANS

OVERALL SITE PLAN & CONTEXT PLAN

SITE PLAN & PROJECT INFORMATION A1.10 SITE DETAILS

A2.01 MAIN FLOOR - SOUTH

A2.02 MAIN FLOOR - NORTH

A2.11 ROOF PLAN & REFLECTED CEILING PLAN

BUILDING ELEVATIONS - WEST & SOUTH A4.11 BUILDING ELEVATIONS - EAST & NORTH

A5.10 **BUILDING SECTIONS** 

**BUILDING SECTIONS** A5.20 WALL SECTIONS

STAIR PLANS, SECTIONS & DETAILS

A7.21 BUILDING DETAILS

DOOR SCHEDULE, DOOR TYPES, FRAME TYPES & HARDWARE CODES

WINDOW SCHEDULE CONSTRUCTION ASSEMBLIES & CODE DETAILS

### ARGUS PROPERTIES LTD.

### KPA PROJECT No. 230457-A

### PROJECT TEAM

ARCHITECT	
KP ARCHITECTURE LTD.	
400 - 34077 GLADYS AVE	NUE
ABBOTSFORD, BC V2S	3E8
ARCHITECT: LARRY POD	HORA, ARCHITECT AIBC, MRAIC
EMAIL: LARRYP@KRAHN	· · · · · · · · · · · · · · · · · · ·
PROJECT MANAGER: BIT	
<b>EMAIL: BITUS@KRAHN.C</b>	OM
_	

KRAHN ENGINEERING LTD. 400 - 34077 GLADYS AVENUE ABBOTSFORD, BC V2S 3E8 PHONE: 604.853.8831 PROJECT MANAGER: XXXXXXXXXX EMAIL: XXXXX@KRAHN.COM TECH LEAD: XXXXXXXX

STRUCTURAL

**MECHANICAL** KD MECHANICAL CONSULTANTS LTD. 400 - 34077 GLADYS AVENUE ABBOTSFORD, BC V2S 3E8 PHONE: 604.853.8831 PROJECT MANAGER: XXXXXXXXXX EMAIL: XXXXX@KRAHN.COM TECH LEAD: XXXXXXXX

### **ELECTRICAL** KD ELECTRICAL CONSULTANTS LTD.

400 - 34077 GLADYS AVENUE ABBOTSFORD, BC V2S 3E8 PHONE: 604.853.8831 PROJECT MANAGER: XXXXXXXXXX EMAIL: XXXXX@KRAHN.COM TECH LEAD: XXXXXXXX

CIVIL CTQ CONSULTANTS LTD. 1334 - ST. PAUL STREET KELOWNA, BC V1Y 2E1 PHONE: 250.979.1221 PROJECT MANAGER: STEVE TOBLER

EMAIL: STOBLER@CTQCONSULTANTS.CA TECH LEAD: ROLAND RUESGEN

CTQ CONSULTANTS LTD. 1334 - ST. PAUL STREET KELOWNA, BC V1Y 2E1 PHONE: 250.979.1221 PROJECT MANAGER: NATALIE MARTIN EMAIL: NMARTIN@CTQCONSULTANTS.CA

FERGUSON LAND SURVEYING & GEOMATICS LTD.

LANDSCAPE

SURVEY

404 - 1630 PANDOSY STREET

KELOWNA, BC V1Y 1P7

PHONE: 250.763.3115

### **GEOTECHNICAL** INTERIOR TESTING SERVICES LTD.

1 - 1965 MOSS COURT KELOWNA, BC V1Y 9L3 PHONE: 250.860.6540 PROJECT MANAGER: JEREMY BLOCK EMAIL: JEREMY@INTERIORTESTING.COM

#### FIRE SUPPRESSION FIRE SUPPRESSION LTD. 400 - 34077 GLADYS AVENUE

ABBOTSFORD, BC V2S 3E8 PHONE: 604.853.8831 PROJECT MANAGER: XXXXXXXXXX EMAIL: XXXXX@FIRE.COM TECH LEAD: XXXXXXXX

#### 1 2025/01/17 ISSUED FOR DEVELOPMENT PERMIT NO. DATE Y/M/D DESCRIPTION ISSUES AND REVISIONS

BEAVER LAKE INDUSTRIAL - BUILDING 7

ABBOTSFORD • EDMONTON • VANCOUVER • TORONTO

This drawing has been prepared solely for the use of ARGUS

PROPERTIES LTD. and there are no representations of any kind made by KP Architecture Ltd. to any party with whom KP Architecture Ltd. has not entered into a contract. This drawing

shall not be used for construction purposes until it is issued

for the purpose.

PROJECT ADDRESS 334 BEAVER LAKE ROAD KELOWNA, BC V4V 1S7

DRAWING TITLE COVER

SCALE	
DRAWN	BSS
REVIEWED	
PROJECT NO.	230457-A





SE PERSPECTIVE\_1

SCALE:



2 SW PERSPECTIVE SCALE:



shall not be used for construction purposes until it is issued for the purpose.

1 2025/01/17 ISSUED FOR DEVELOPMENT PERMIT

BEAVER LAKE INDUSTRIAL

NO. DATE Y/M/D DESCRIPTION

ISSUES AND REVISIONS

PROJECT NAME

- BUILDING 7

PROJECT ADDRESS

DRAWING TITLE

334 BEAVER LAKE ROAD KELOWNA, BC V4V 1S7


PERSPECTIVES




3 SE PERSPECTIVE\_2 SCALE:

SCALE

DRAWN REVIEWED PROJECT NO. 230457-A DRAWING NO.

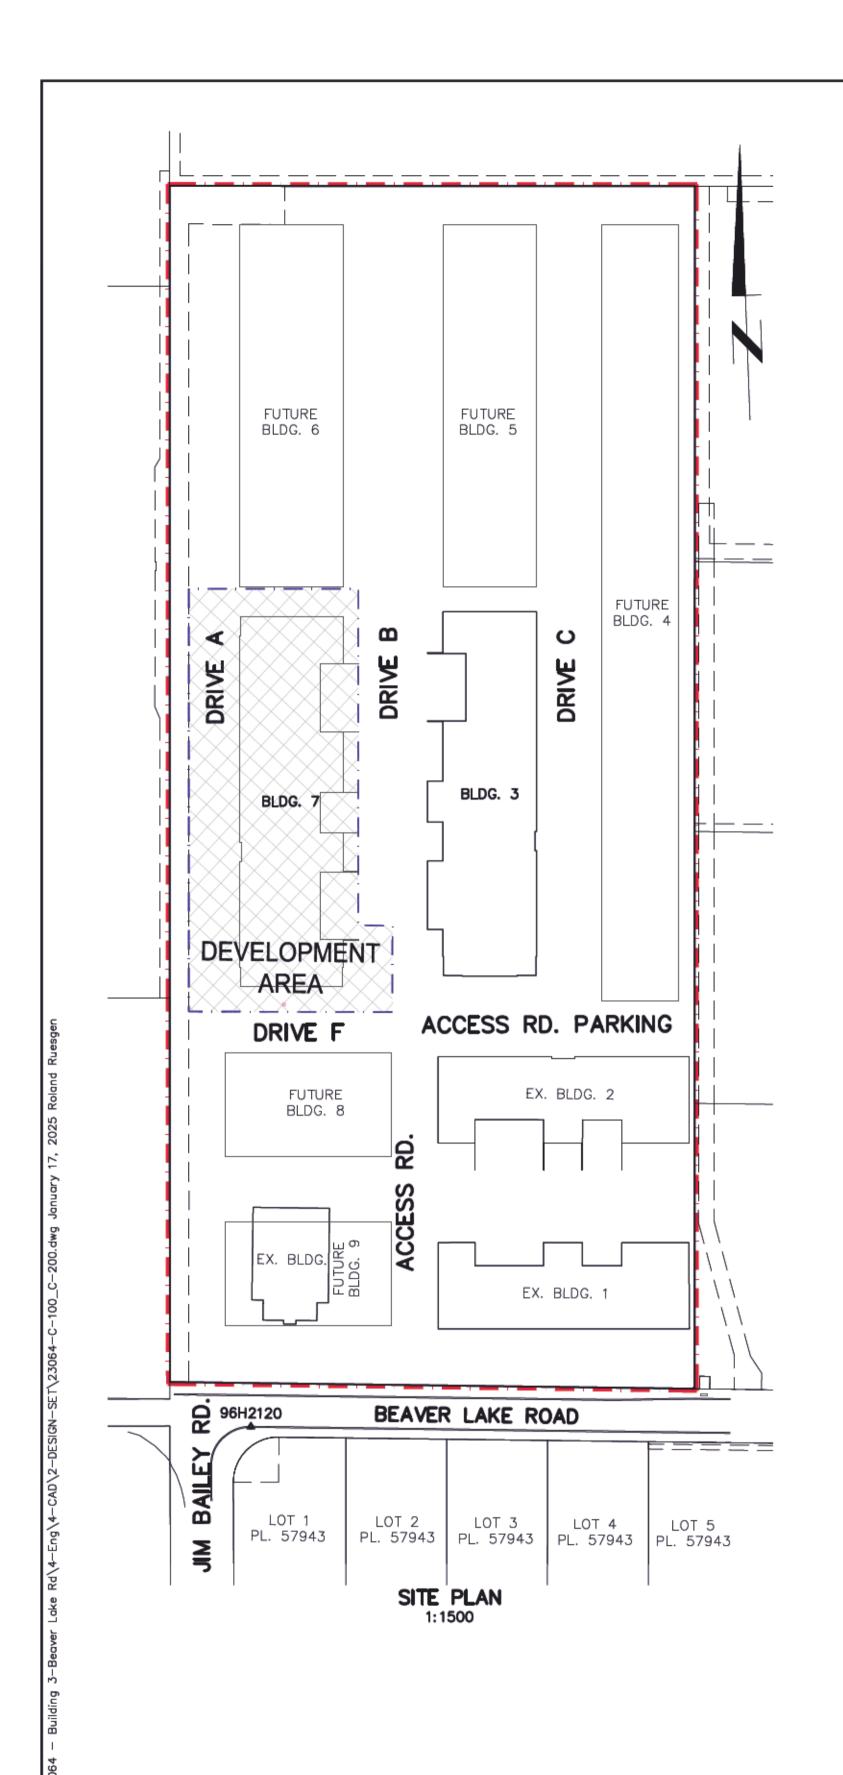

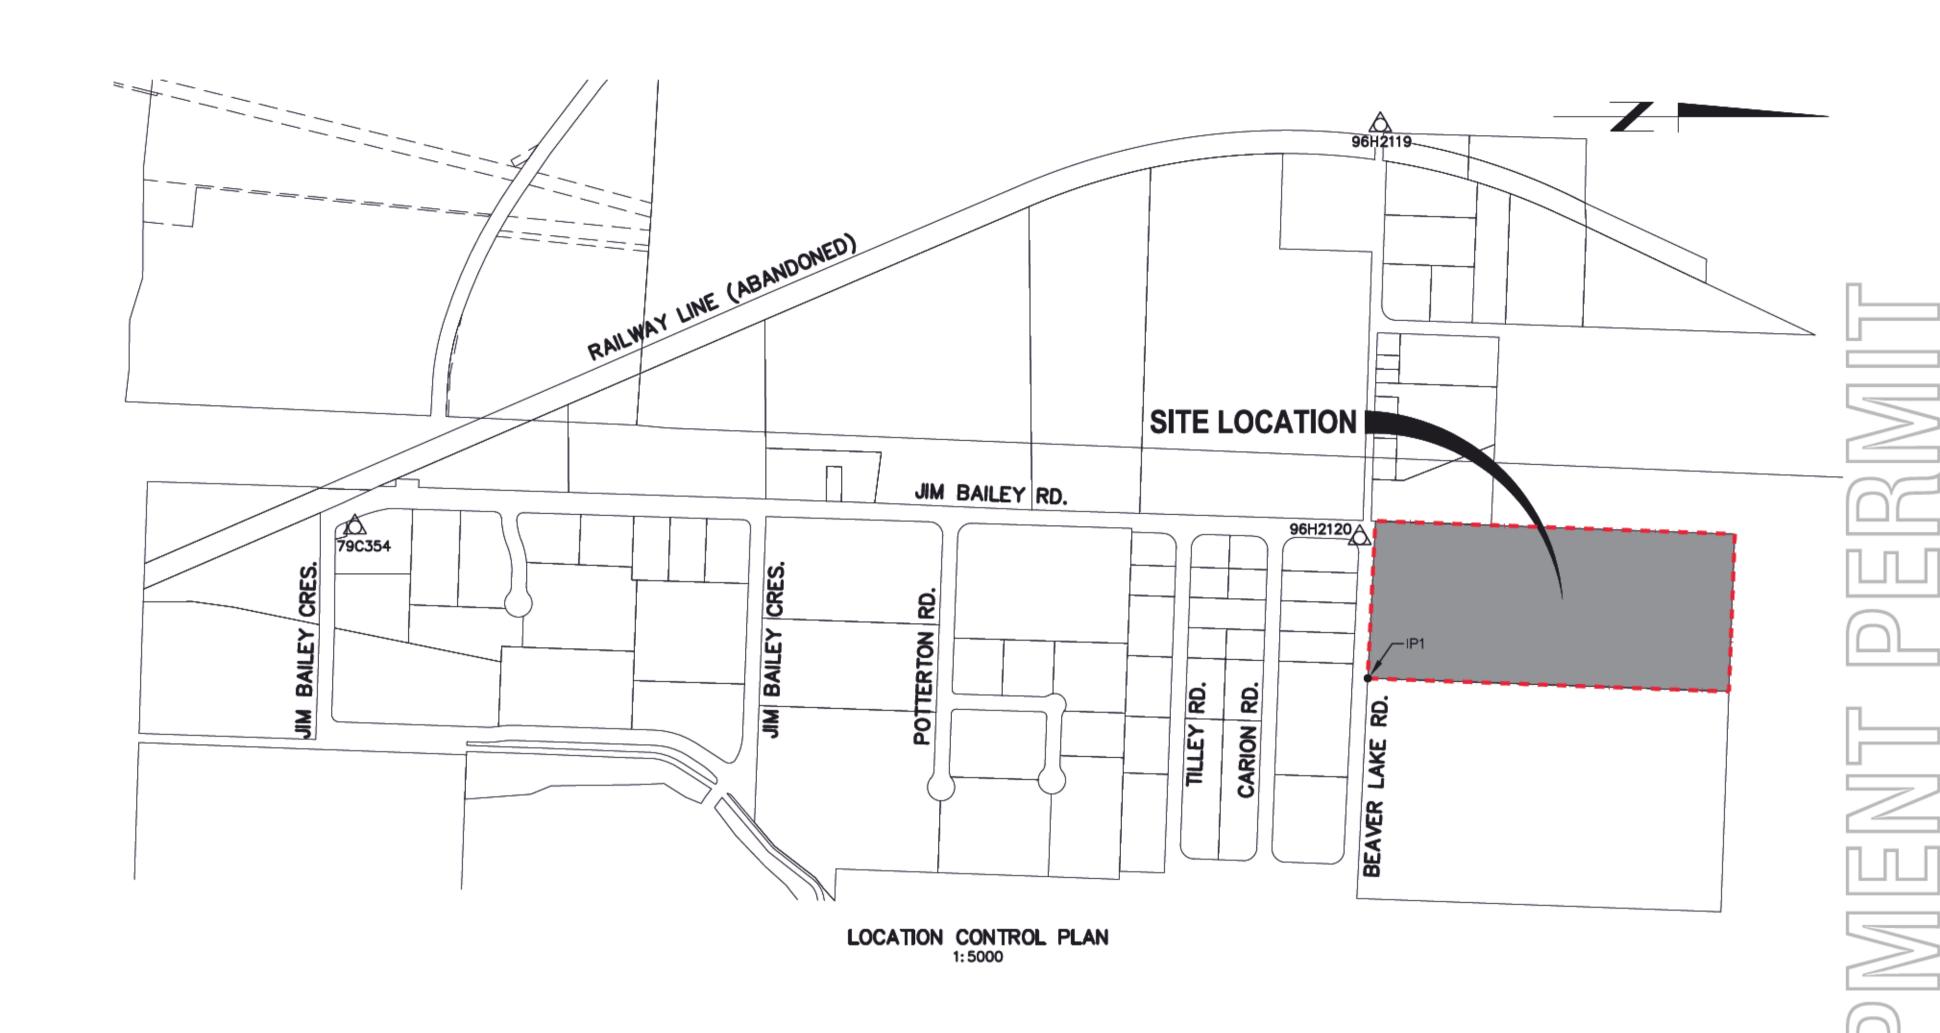

# LIST OF DRAWINGS

C-200 LOCATION PLAN

C-201 NOTES

C-202 SITE SERVICING PLAN

C-203 OVERALL WATER PLAN

C-204 SITE GRADING PLAN

C-205 STORMWATER MANAGMENT PLAN

C-206 EROSION CONTROL PLAN

C-207 TEMP. RETAINING WALL DETAILS

C-208 SEWER DETAILS

C-209 WATER & ROAD DETAILS

C-210 DRAINAGE SRW PLAN

	SITE CONTROL POINTS								
CONTROL ID	CONTROL ID UTM NORTHING UTM EASTING PROJECT NORTHING PROJECT EASTING ELEVATION								
IP1	5543613.824	328869.506	5543613.824	328869.506	438.723				
96H2120	5543606.245	328693.025	5543606.244	328693.007	435.545				
96H2119	5543625.909	328141.765	5543625.910	328141.689	426.929				
79C354	5542270.000	328670.000	5542269.860	328669.979	435.841				

SCALE FA	CTOR BASE	POINT				
CONTROL ID NORTHING EASTING						
IP1	5543613.824	328869.506				
CONVERSION TYPE   SCALE E						

CONVERSION TYPE	SCALE FACTOR
GRID (UTM) TO GROUND (PROJECT)	1.00010408
GROUND (PROJECT) TO GRID (UTM)	0.9998959

- CTQ DESIGN IS BASED ON LOCALIZED PROJECT COORDINATE SYSTEM. HORIZONTAL DISTANCES ARE GROUND LEVEL DISTANCES.
  CONTROL POINTS ARE BASED ON GOVERNMENT MONUMENT COORDINATES.
   CTQ DESIGN ELEVATIONS ARE BASED ON CONTROL ID IP1. OTHER ELEVATIONS ARE PROVIDED AS CHECK ONLY.

- 3. ELEVATION DATUM IS NAD 83 / (CGG2013).
  4. SURVEYORS ARE RESPONSIBLE FOR VERIFYING DATA. ANY CHANGE IN SURVEYOR OR EQUIPMENT SURVEY RESIDUAL SHOULD BE CALIBRATED.


1 25.01.20 NP DEVELOPMENT PERMIT  ST  Association flession of Segments and Goscienting Supplied of British Columbia  S. M. TOBLER  PROPESSIONAL  LICENSEE ENGINEERING Licensee 55120											
Association of fession to fession	No.	YY.MM.DD	Ву	Issued	Chkd	No.	YY.MM.DD	Ву	Revision	Chkd	Licence 55120
G Association Affession b Engineers and Goscienti b of be Regarded of British Columbia C S. M. TOBLER FROPESSIONAL	1	25.01.20	NP	DEVELOPMENT PERMIT	ST						engineering
W Association of Session by Engineers and Conscienting of the Loganee of British Columbia											
Segment of fession to											S.M. TOBLER
Association of fession to Faginets and Classiantia											b of he Regimee of
Acceptace and a second a second and a second a second and											Massociation Infessional
											*CCCCCCCCCCCC

Drawn	RR	1774 CT DAUI CTDEET
Design	NP	KELOWNA BC V1Y 2E1
Approv	red	7 3
Date	JANUARY 2025	
Scale		$\neg$
	AS NOTED	

T 1	CTG ENGINEERING LANDSCAPE ARCHITECTURE URBAN PLANNING	TEL <b>250 979</b> — www.ctqconsulto
334	BEAVER LAKE ROAD	
	BUILDING 7	
	LOCATION PLAN	

Division MUNICIPAL C-200

23064

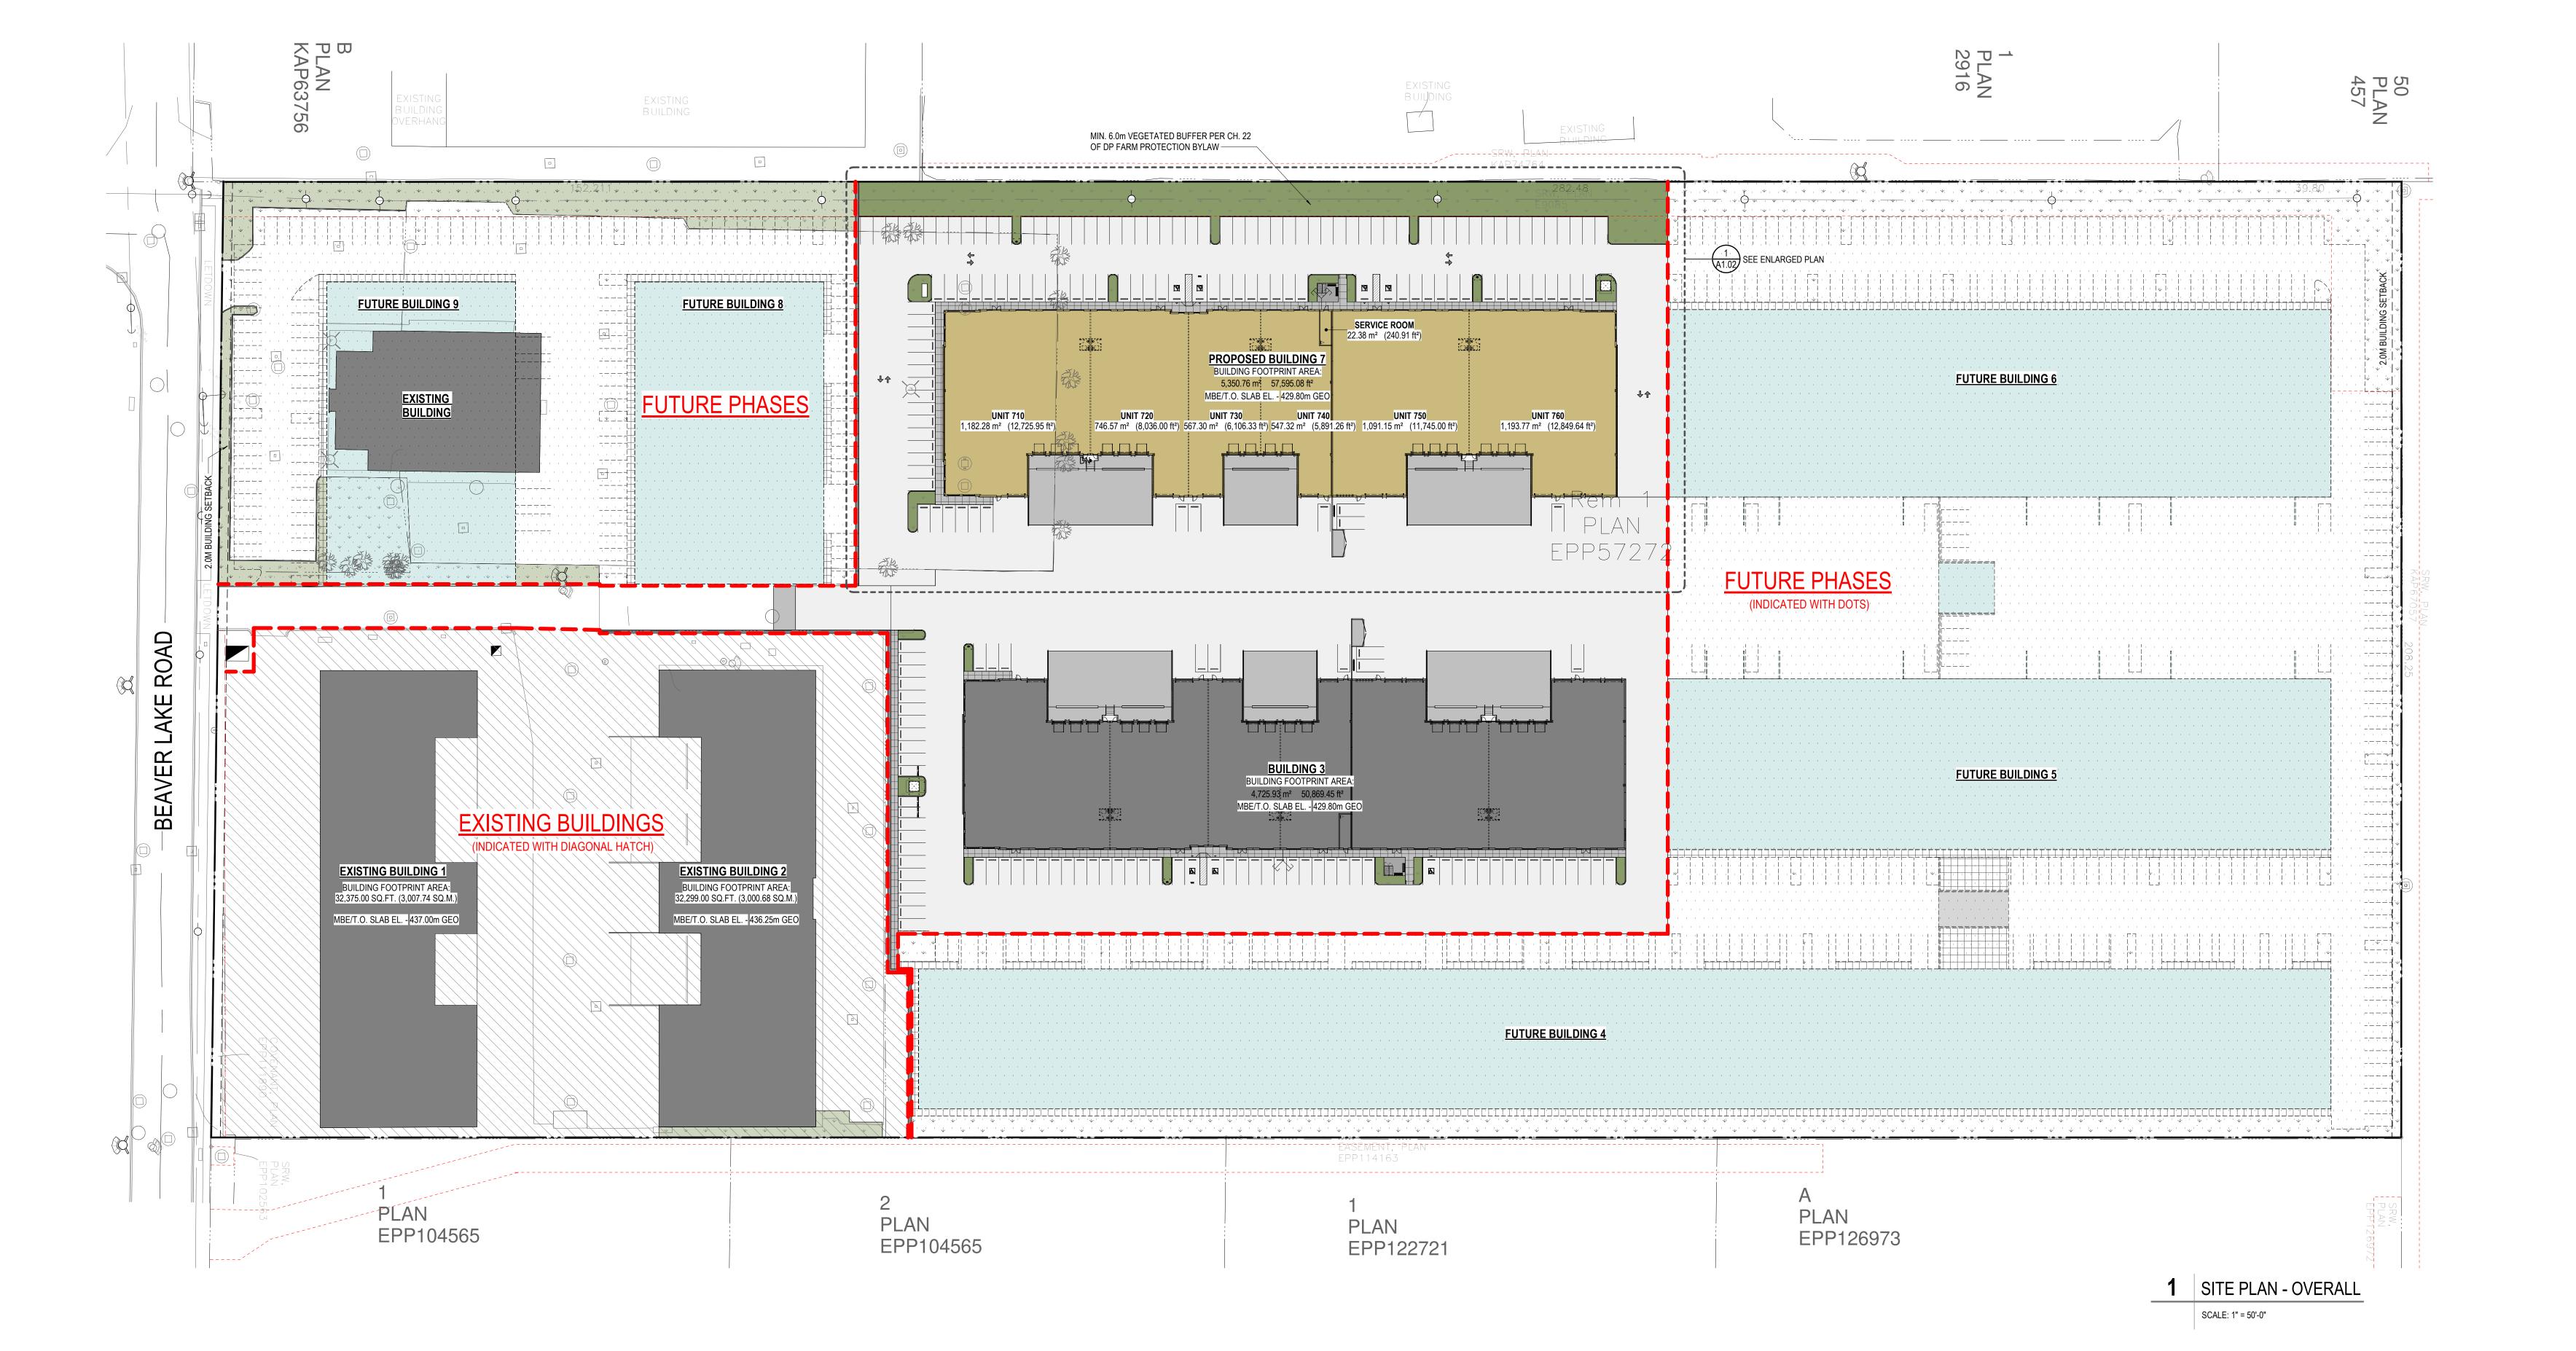

**CONTEXT PLAN** 

BEAVER LAKE RD

3RD AVE 6TH AVE 8TH AVE 10TH AVE 11TH AVE



ABBOTSFORD OFFICE #400 - 34077 GLADYS AVE ABBOTSFORD, BC V2S 2E8 T 604.853.8831 F 604.850.1580 WWW.KRAHN.COM

This drawing has been prepared solely for the use of ARGUS PROPERTIES LTD. and there are no representations of any kind made by KP Architecture Ltd. to any party with whom KP Architecture Ltd. has not entered into a contract. This drawing shall not be used for construction purposes until it is issued for the purpose.

1 2025/01/17 ISSUED FOR DEVELOPMENT PERMIT NO. DATE Y/M/D DESCRIPTION ISSUES AND REVISIONS

BEAVER LAKE INDUSTRIAL - BUILDING 7

PROJECT ADDRESS 334 BEAVER LAKE ROAD KELOWNA, BC V4V 1S7

DRAWN

REVIEWED

PROJECT NO.

DRAWING NO.


DRAWING TITLE OVERALL SITE PLAN & CONTEXT PLAN


As indicated

BSS

230457-A

ARCH E1 TIE

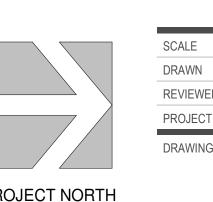

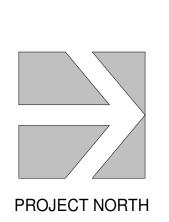

PROJECT SITE

CARION RD

BUBNARD

TILLEY RD

CLASS 1 BIKE



This drawing has been prepared solely for the use of ARGUS PROPERTIES LTD. and there are no representations of any kind made by KP Architecture Ltd. to any party with whom KP Architecture Ltd. has not entered into a contract. This drawing shall not be used for construction purposes until it is issued for the purpose.

**EDMONTON** 

1 2025/01/17 ISSUED FOR DEVELOPMENT PERMIT NO. DATE Y/M/D DESCRIPTION ISSUES AND REVISIONS

#### **ZONING BY-LAW ANALYSIS** PROJECT DATA 334 BEAVER LAKE ROAD, KELOWNA, BC BUILDING USE: MULTI-TENANT MEDIUM HAZARD INDUSTRIAL 6. LANDSCAPING REQUIREMENTS: LEGAL ADDRESS: LOT 1 SECTION 11 TOWNSHIP 20 OSOYOOS DIVISION YALE DISTRICT PLAN EPP57272 LANDSCAPING AREA, LANDSCAPING SCREENS, AND FENCING SHALL COMPLY WITH CITY OF KELOWNA BYLAW REQUIREMENTS. BUILDING AREA (MAIN FLOOR): 5,350.76 m<sup>2</sup> 57,595.08 ft<sup>2</sup> MAXIMUM NUMBER OF PARKING STALLS IN A CONSECUTIVE ROW IS 15 WITH A LANDSCAPED ISLAND OR DRIVE AISLE SEPARATING THE NEXT 15 STALLS. **ZONING BYLAW ANALYSIS (CITY OF KELOWNA)** . VEHICLE PARKING AND LOADING: REFER TO LOCAL ZONING REQUIREMENTS FOR USE CLASSIFICATION AND PARKING REQUIREMENTS. REFER TO LOCAL ZONING REQUIREMENTS FOR USE CLASSIFICATION AND PARKING REQUIREMENTS. 13 - HEAVY INDUSTRIAL ALL AREAS ARE BASED ON GROSS AREA CALCULATIONS, UNLESS NOTED OTHERWISE. ALL AREAS ARE BASED ON GROSS AREA CALCULATIONS, UNLESS NOTED OTHERWISE. BICYCLE PARKING REQUIREMENT CALCULATIONS 2. SITE AREA: 99,080.67 m<sup>2</sup> 9.91 hectare 1,066,495.48 ft<sup>2</sup> 24.48 acres VEHICLE PARKING REQUIREMENT CALCULATIONS LOCAL BYLAW 3. SITE COVERAGE + BUILDING AREAS: LOCAL BYLAW REQUIREMENTS REQUIREMENTS CLASSIFICATION BY-LAW DEFINITION CALCULATION GROSS AREA PERCENTAGE OF SPACES AREA SPACES BUILDING FOOTPRINT AREA CALCULATIONS **GROSS AREA** METHOD SQ M SQ FT GROSS AREA (%) BYLAW SPACES - | CLASS 1 BYLAW DEFINITION CALCULATION SQ M SQ FT PERCENTAGE OF CLASS 1 BYLAW CLASS 1 (SECURED) SITE AREA PROP. SITE BUILDING AREA MAXIMUM SITE COVERAGE MAIN FLOOR INDUSTRIAL 1 SPACE FOR EACH GROSS AREA 5,350.76 m<sup>2</sup> 57,595.08 ft<sup>2</sup> 100 USED METHOD GROSS AREA (SECURED) AREA SPACES REQUIRED COVERAGE SQ M SQ FT % SQ M SQ FT 100 S.M. (1076.40 S.F.) 0.05 SPACE FOR EACH GROSS AREA 5,350.76 57,595.08 100 BUILDING 3 | 99,080.67 m² | 1,066,495.48 ft² | 4.77% | 4,725.93 m² | 50,869.45 ft² | 80.00% | 79,264.54 m² | 853,196.38 ft² 2.5 SPACES FOR GROSS AREA 802.62 m<sup>2</sup> 8,639.31 ft<sup>2</sup> 100 SECOND FLOOR OFFICE 2.5 100.00 20.07 100 S.M. (1076.40 S.F.) BUILDING 7 99,080.67 m<sup>2</sup> 1,066,495.48 ft<sup>2</sup> 5.40% 5,350.76 m<sup>2</sup> 57,595.08 ft<sup>2</sup> 80.00% 79,264.54 m<sup>2</sup> 853,196.38 ft<sup>2</sup> (FUTURE 15% SECOND FLOOR 0.05 SPACE FOR EACH GROSS AREA 802.62 8,639.31 100 100.00 m<sup>2</sup> 0.40 EXIST. BUILDING 1 99,080.67 m<sup>2</sup> 1,066,495.48 ft<sup>2</sup> 3.04% 3,007.74 m<sup>2</sup> 32,375.00 ft<sup>2</sup> 80.00% 79,264.54 m<sup>2</sup> 853,196.38 ft<sup>2</sup> 100 S.M. (1076.40 S.F.) BUILDOUT) (FUTURE 15% BUILDOUT) | 100 S.M. (1076.40 S.F.) TOTAL VEHICLE PARKING SPACES REQUIRED: EXIST. BUILDING 2 99,080.67 m<sup>2</sup> 1,066,495.48 ft<sup>2</sup> 3.03% 3,000.68 m<sup>2</sup> 32,299.00 ft<sup>2</sup> 80.00% 79,264.54 m<sup>2</sup> 853,196.38 ft<sup>2</sup> 6,153.38 m<sup>2</sup> 66,234.39 ft<sup>2</sup> TOTAL BICYCLEPARKING SPACES REQUIRED: 6,153.38 66,234.39 EXIST. BUILDING 99,080.67 m<sup>2</sup> 1,066,495.48 ft<sup>2</sup> 1.31% 1,294.51 m<sup>2</sup> 13,934.02 ft<sup>2</sup> 80.00% 79,264.54 m<sup>2</sup> 853,196.38 ft<sup>2</sup> VEHICLE PARKING PROVIDED BICYCLE PARKING PROVIDED 17.54% 17,379.61 m<sup>2</sup> 187,072.56 ft<sup>2</sup> TOTAL PARKING TYPE No. of SPACES BICYCLES ACCESSIBLE PARKING

2.50 m (8.20') W, 6.00 m (19.68') L (2.74 m (9.00') W PROVIDED)

3.00 m (9.84') W, AREA TO BE NO LESS THAN 28.00 m<sup>2</sup> (301.39 ft<sup>2</sup>)

2.30 m (7.55') W, 4.80 m (15.75') L

6.50 m (21.33') at 90° (TWO WAY)

3.70 m (12.14') W, 6.00 m (19.68') L (+ 1.50 m (4.92') W ADJACENT ACCESS AISLE BTWN 2 STALLS)

4.80 m (15.75') W, 6.00 m (19.68') L (W INCLUDES 1.50 m (4.92') ADJACENT ACCESS AISLE)

GROSS FLOOR AREA CALCULATIONS

MAIN FLOOR

TOTAL

4. BUILDING HEIGHT:

MAXIMUM HEIGHT:

PROPOSED HEIGHT:

5. REQUIRED SETBACKS:

SIDE YARD (WEST):

SIDE YARD (EAST):

FRONT YARD (SOUTH):

REAR YARD (NORTH):

SECOND FLOOR

(FUTURE 15% BUILDOUT)

OCCUPANCY FLOOR AREA

2.00 m (6.56') 157.24 m (515.89')

0.00 m (0.00') 27.86 m (91.40')

2.00 m (6.56') 170.79 m (560.32')

18.00 m (59.06')

10.97 m (36.00')

0.00 m (0.00')

802.62 m<sup>2</sup> 8,639.31 ft<sup>2</sup>

6,153.38 m<sup>2</sup> 66,234.39 ft<sup>2</sup>

PROVIDED (B7)

139.54 m (457.82')

F.A.R. CALCULATIONS

SQ M SQ FT SQ M F.A.R. F.A.R.

5,350.76 m<sup>2</sup> 57,595.08 ft<sup>2</sup> 203,343.11 ft<sup>2</sup> 18,891.19 m<sup>2</sup> 0.19 0.75

BUILDING AREA PROPOSED ALLOWABLE

STANDARD PARKING

STALL DIMENSIONS:

STANDARD STALL:

LOADING STALL:

DRIVE AISLE WIDTH:

LOADING CALCULATION:

CAR ACCESSIBLE STALL

VAN ACCESSIBLE STALL:

SMALL CAR STALL (MAX. 30%):

TOTAL PARKING SPACES PROVIDED 129

STANDARD STALL ADJACENT STRUCTURE: 2.70 m (8.86') W, 6.00 m (19.68') L

TOTAL LOADING SPACES REQUIRED 1 SPACE FOR EACH 1,900 S.M. (20,451,43 S.F.) = 3

TOTAL LOADING SPACES PROVIDED 25 (DOCK LOADING & GRADE LOADING)

112 2232113	
PROPOSED BUILDING	PROPERTY LINE
EXISTING BUILDING	EASEMENT/ROW
LANDSCAPING SEE LANDSCAPING DWGS	——————— BUILDING SETBACK
BUILDING SIDEWALK	imes $ imes$ CHAINLINK/MESH FENCE
CONCRETE PAD	■ ■ ■ CONCRETE SOUND BARRIER
ASPHALT PAVEMENT SEE CIVIL DWGS	O O O O O OMEGA FENCE
PERMEABLE ASPHALT PAVEMENT, SEE CIVIL DWGS	RETAINING WALL SEE CIVIL & STRUCT. DWGS
MASONRY PAVEMENT SEE LANDSCAPING DWGS	CATCH BASIN & LAWN DRAIN SEE CIVIL & MECH. DWGS
GRAVEL	STRIP DRAIN SEE CIVIL & MECH. DWGS
MULCH SEE LANDSCAPING DWGS	VEHICLE PAINTED TRAFFIC DIRECTION ARROW
PMT C/W BOLLARDS	BUILDING FACADE LIGHTS SEE ELEC. DWGS
SEE ELEC. DWGS	POST MOUNTED LIGHTS SEE ELEC. DWGS
FIRE HYDRANT SEE MECH. DWGS	SITE FURNITURE SEE LANDSCAPING DWGS

SITE LEGEND

SCALE: 1/16" = 1'-0"

BEAVER LAKE INDUSTRIAL - BUILDING 7


PROJECT ADDRESS 334 BEAVER LAKE ROAD KELOWNA, BC V4V 1S7

DRAWING TITLE SITE PLAN & PROJECT **INFORMATION** 

SCALE DRAWN REVIEWED

PROJECT NORTH

As indicated BSS 230457-A PROJECT NO. DRAWING NO.

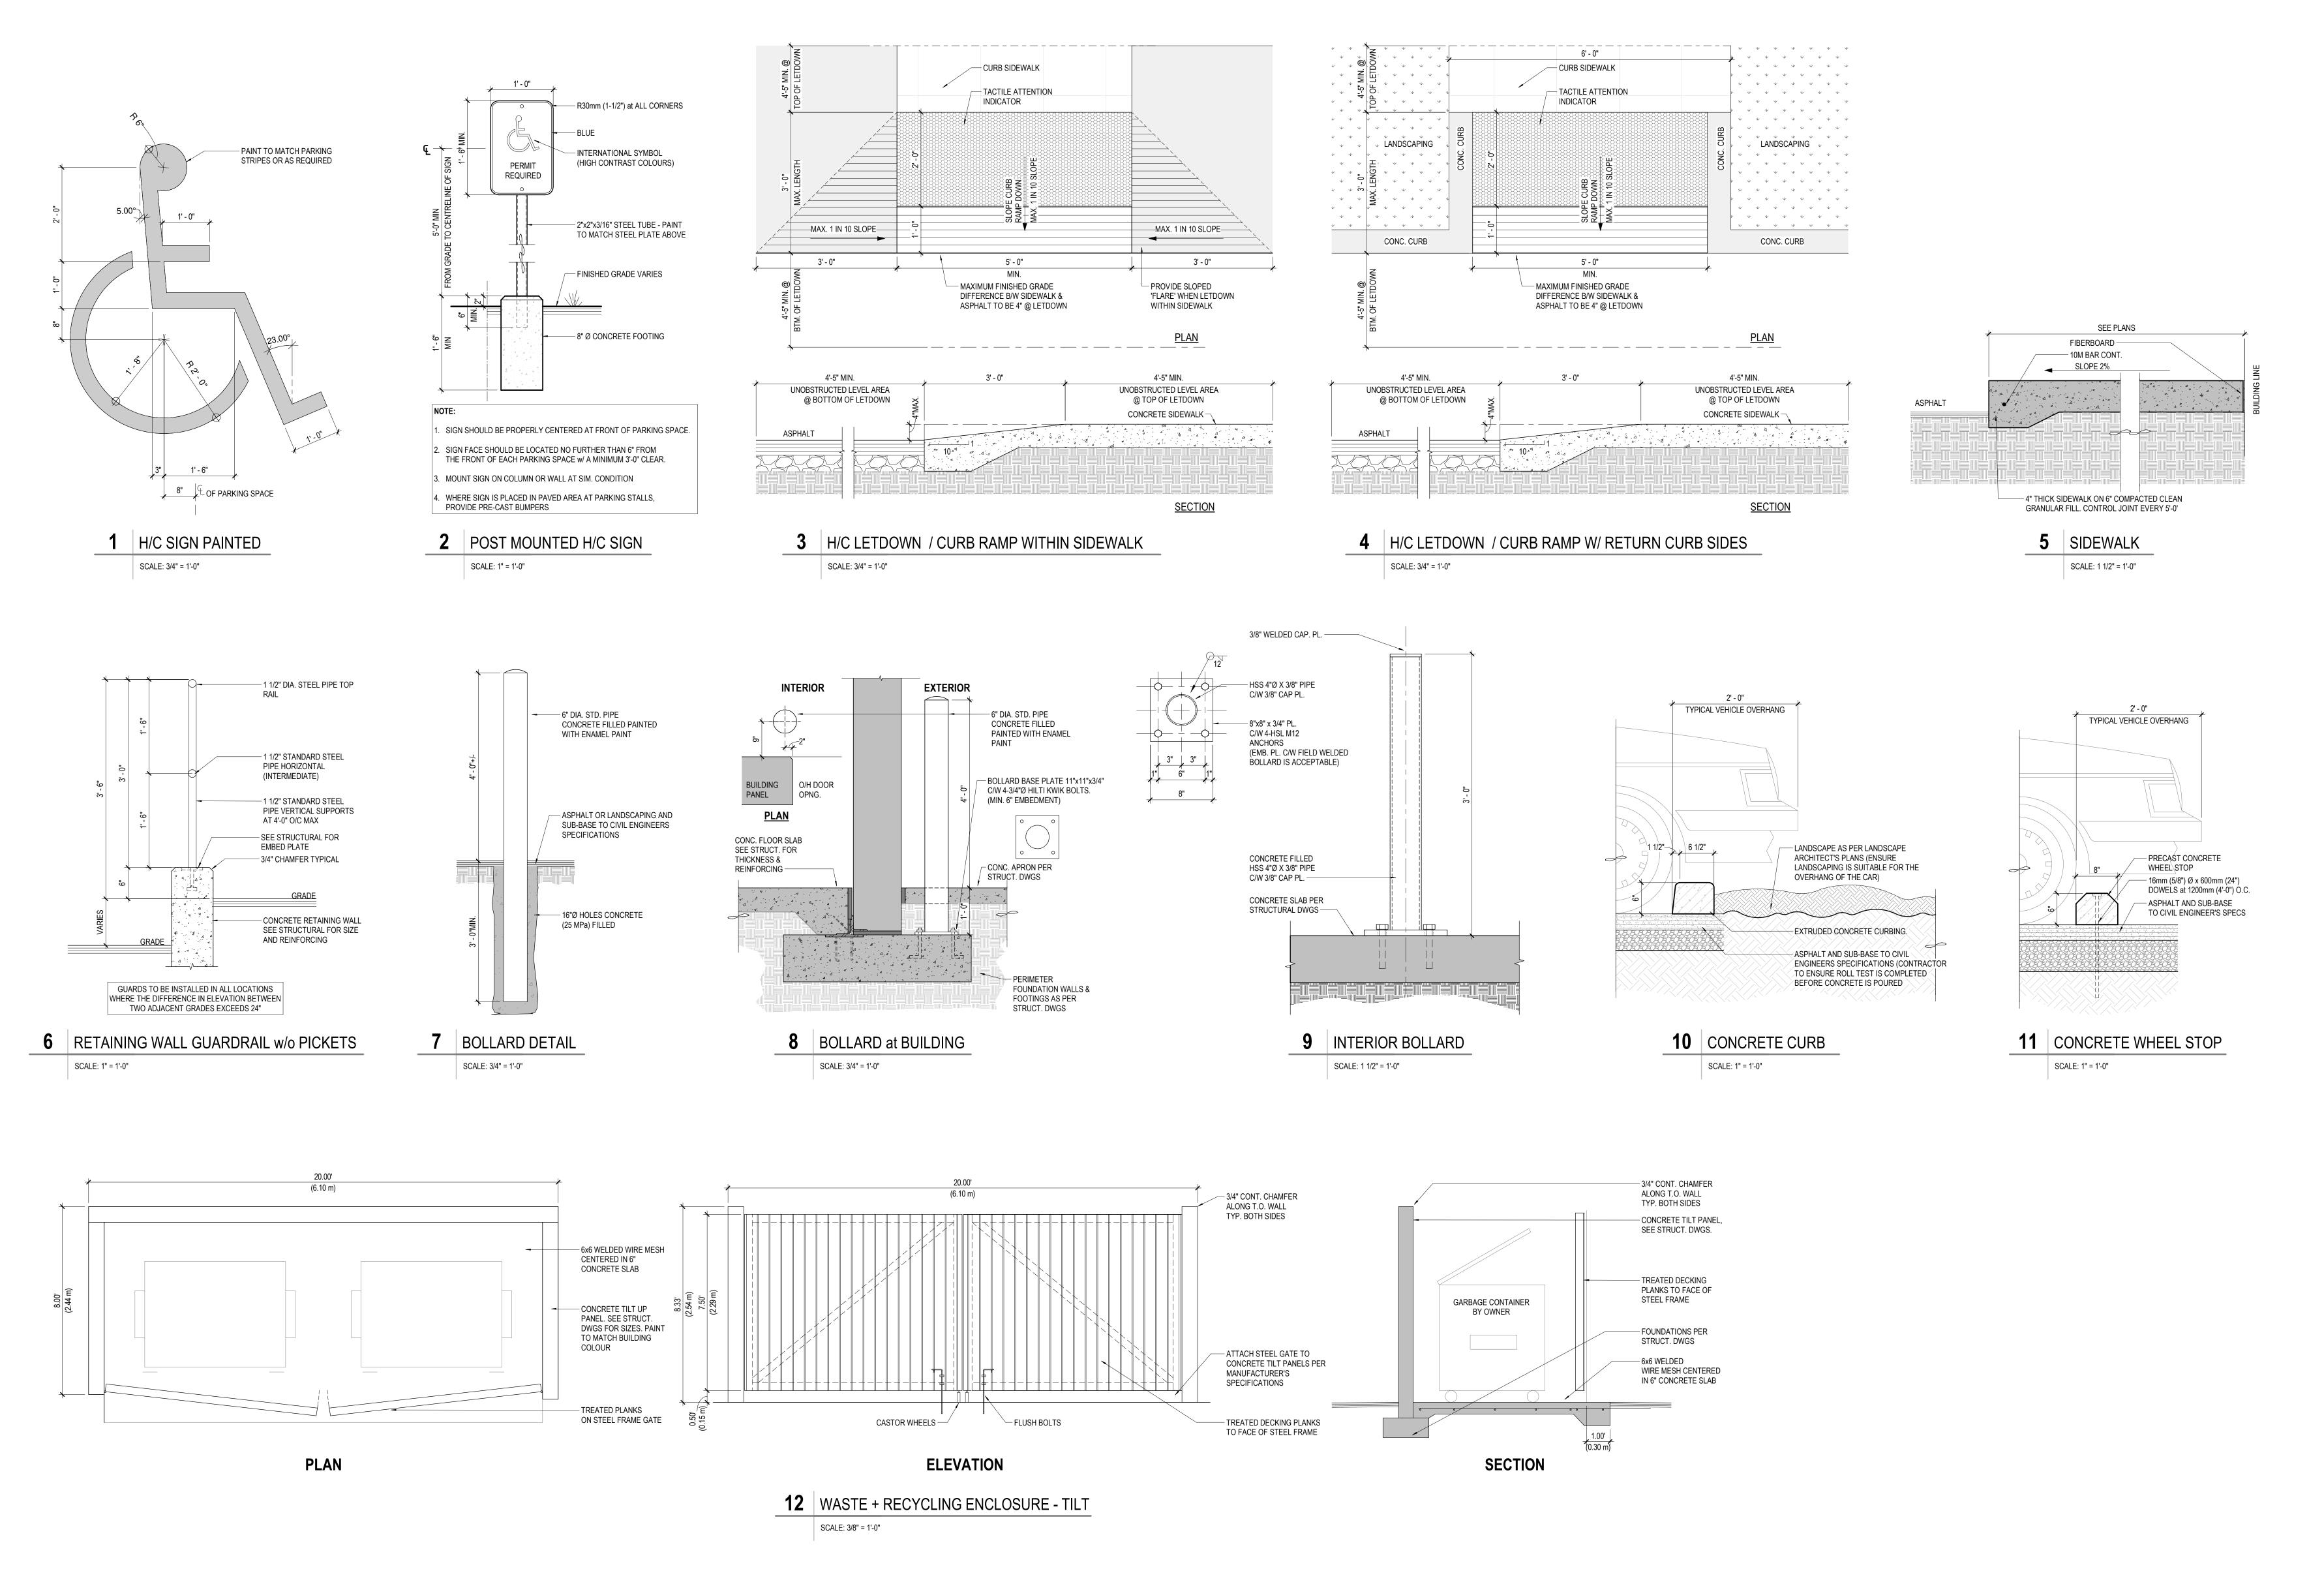







This drawing has been prepared solely for the use of ARGUS PROPERTIES LTD. and there are no representations of any kind made by KP Architecture Ltd. to any party with whom KP Architecture Ltd. has not entered into a contract. This drawing shall not be used for construction purposes until it is issued for the purpose.

1 2025/01/17 ISSUED FOR DEVELOPMENT PERMIT NO. DATE Y/M/D DESCRIPTION ISSUES AND REVISIONS

PROJECT NAME

BEAVER LAKE INDUSTRIAL - BUILDING 7


PROJECT ADDRESS 334 BEAVER LAKE ROAD KELOWNA, BC V4V 1S7


DRAWING TITLE SITE DETAILS

DRAWING NO.

REVIEWED PROJECT NO. 230457-A

**A1.10** 

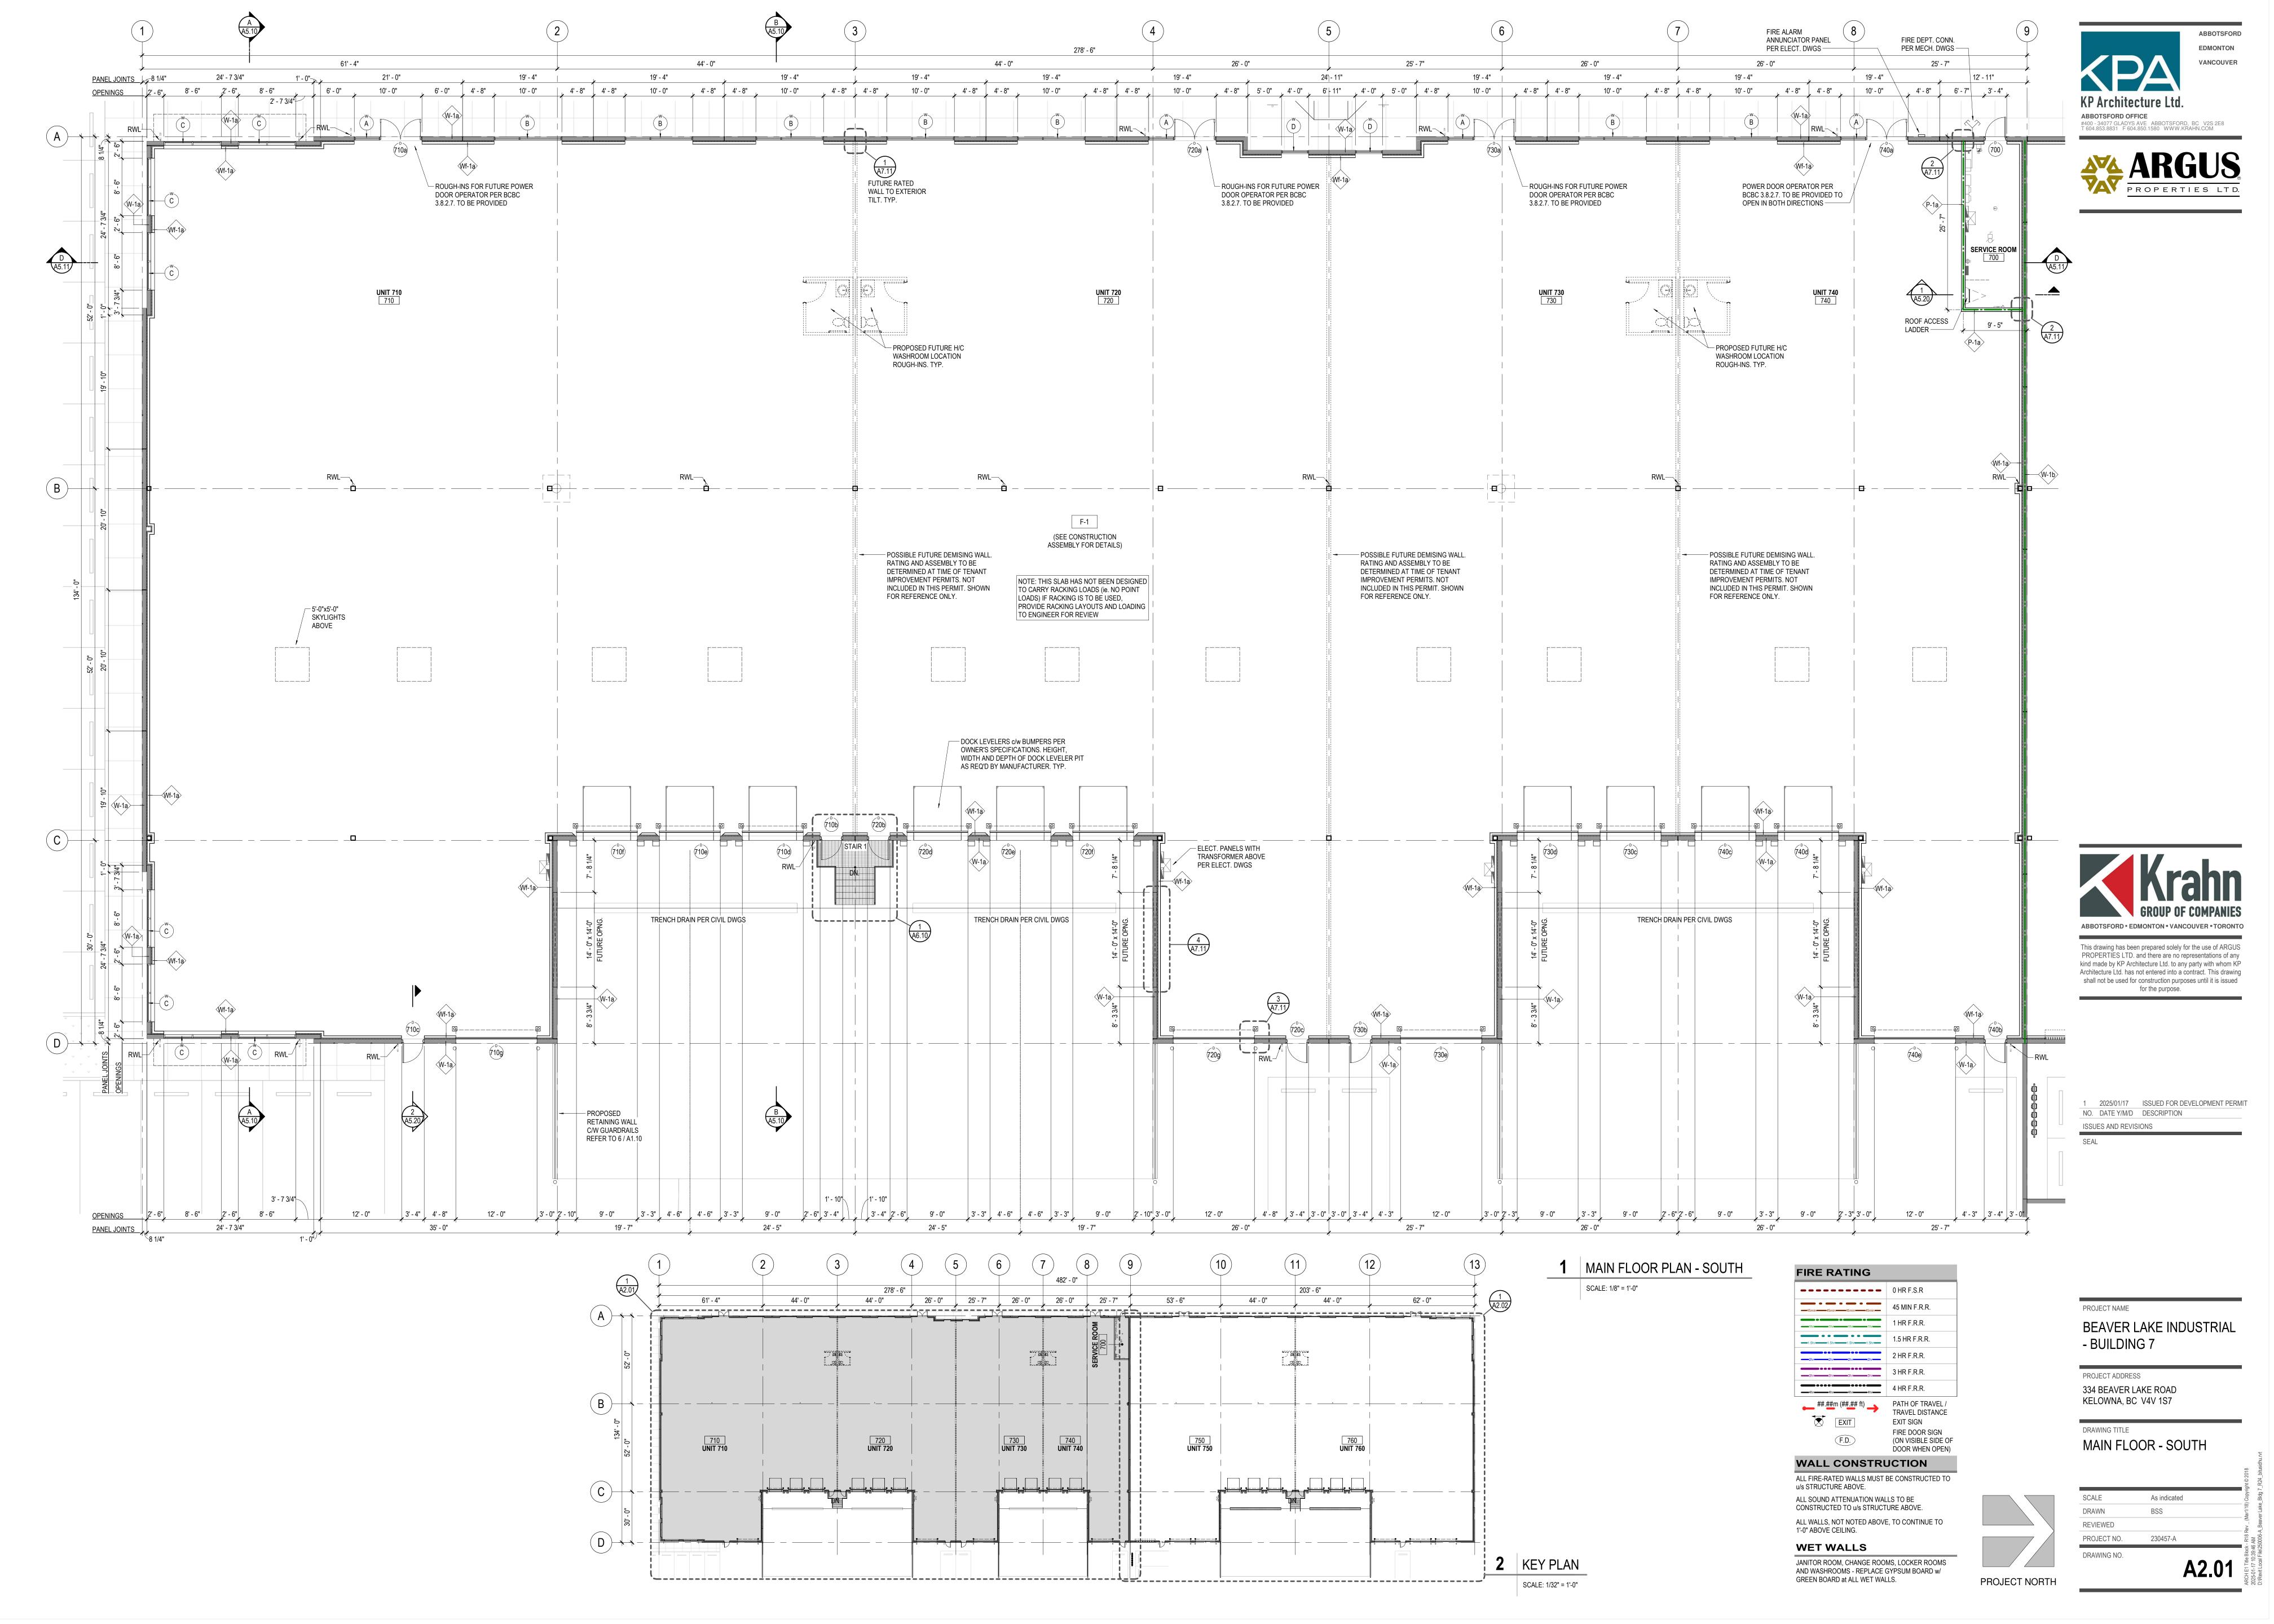

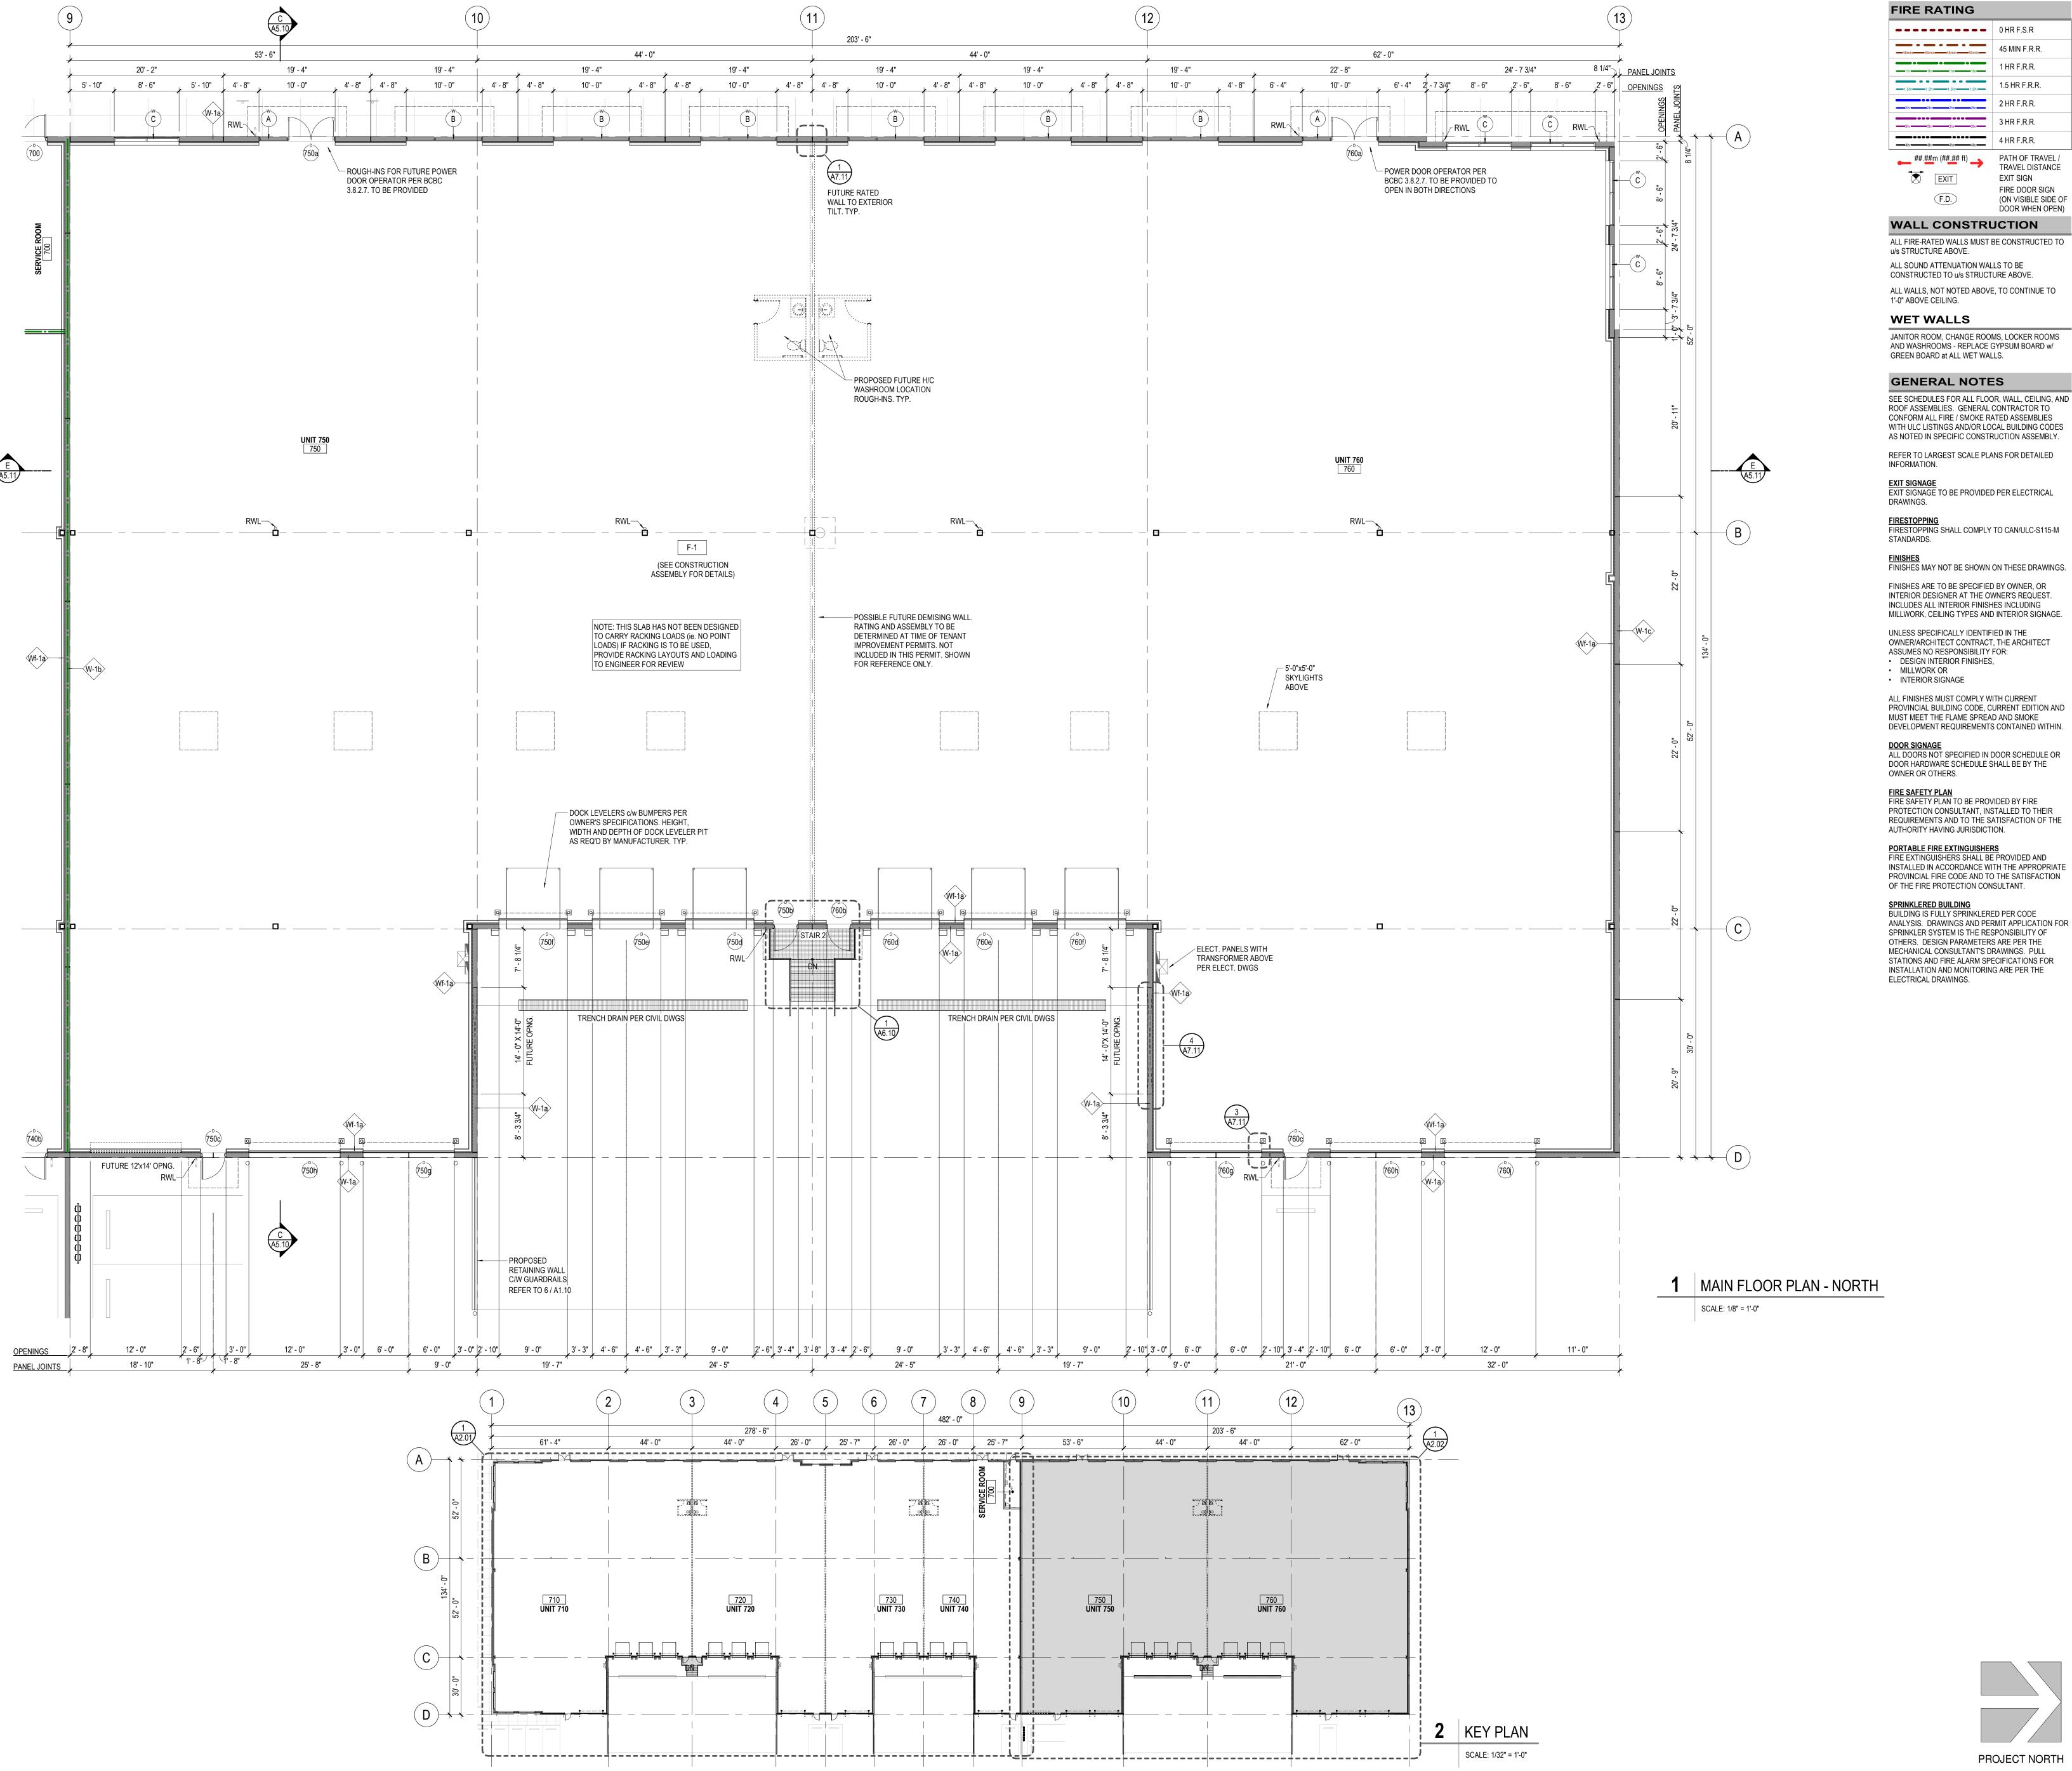

ABBOTSFORD OFFICE #400 - 34077 GLADYS AVE ABBOTSFORD, BC V2S 2E8 T 604.853.8831 F 604.850.1580 WWW.KRAHN.COM

**EDMONTON** 

VANCOUVER

PATH OF TRAVEL / TRAVEL DISTANCE EXIT SIGN FIRE DOOR SIGN (ON VISIBLE SIDE OF DOOR WHEN OPEN)

ALL WALLS, NOT NOTED ABOVE, TO CONTINUE TO

JANITOR ROOM, CHANGE ROOMS, LOCKER ROOMS AND WASHROOMS - REPLACE GYPSUM BOARD w/

ROOF ASSEMBLIES. GENERAL CONTRACTOR TO CONFORM ALL FIRE / SMOKE RATED ASSEMBLIES WITH ULC LISTINGS AND/OR LOCAL BUILDING CODES AS NOTED IN SPECIFIC CONSTRUCTION ASSEMBLY.

## FIRESTOPPING SHALL COMPLY TO CAN/ULC-S115-M

FINISHES ARE TO BE SPECIFIED BY OWNER, OR INTERIOR DESIGNER AT THE OWNER'S REQUEST. INCLUDES ALL INTERIOR FINISHES INCLUDING MILLWORK, CEILING TYPES AND INTERIOR SIGNAGE.

OWNER/ARCHITECT CONTRACT, THE ARCHITECT

PROVINCIAL BUILDING CODE. CURRENT EDITION AND MUST MEET THE FLAME SPREAD AND SMOKE

DOOR HARDWARE SCHEDULE SHALL BE BY THE

PROTECTION CONSULTANT, INSTALLED TO THEIR REQUIREMENTS AND TO THE SATISFACTION OF THE

INSTALLED IN ACCORDANCE WITH THE APPROPRIATE PROVINCIAL FIRE CODE AND TO THE SATISFACTION

ANALYSIS. DRAWINGS AND PERMIT APPLICATION FOR SPRINKLER SYSTEM IS THE RESPONSIBILITY OF OTHERS. DESIGN PARAMETERS ARE PER THE MECHANICAL CONSULTANT'S DRAWINGS. PULL STATIONS AND FIRE ALARM SPECIFICATIONS FOR INSTALLATION AND MONITORING ARE PER THE



This drawing has been prepared solely for the use of ARGUS PROPERTIES LTD. and there are no representations of any kind made by KP Architecture Ltd. to any party with whom KP Architecture Ltd. has not entered into a contract. This drawing shall not be used for construction purposes until it is issued for the purpose.

1 2025/01/17 ISSUED FOR DEVELOPMENT PERMIT

NO. DATE Y/M/D DESCRIPTION

PROJECT NAME


BEAVER LAKE INDUSTRIAL - BUILDING 7

PROJECT ADDRESS 334 BEAVER LAKE ROAD KELOWNA, BC V4V 1S7

DRAWING TITLE MAIN FLOOR - NORTH

As indicated BSS REVIEWED PROJECT NO. DRAWING NO.

**A2.02** 

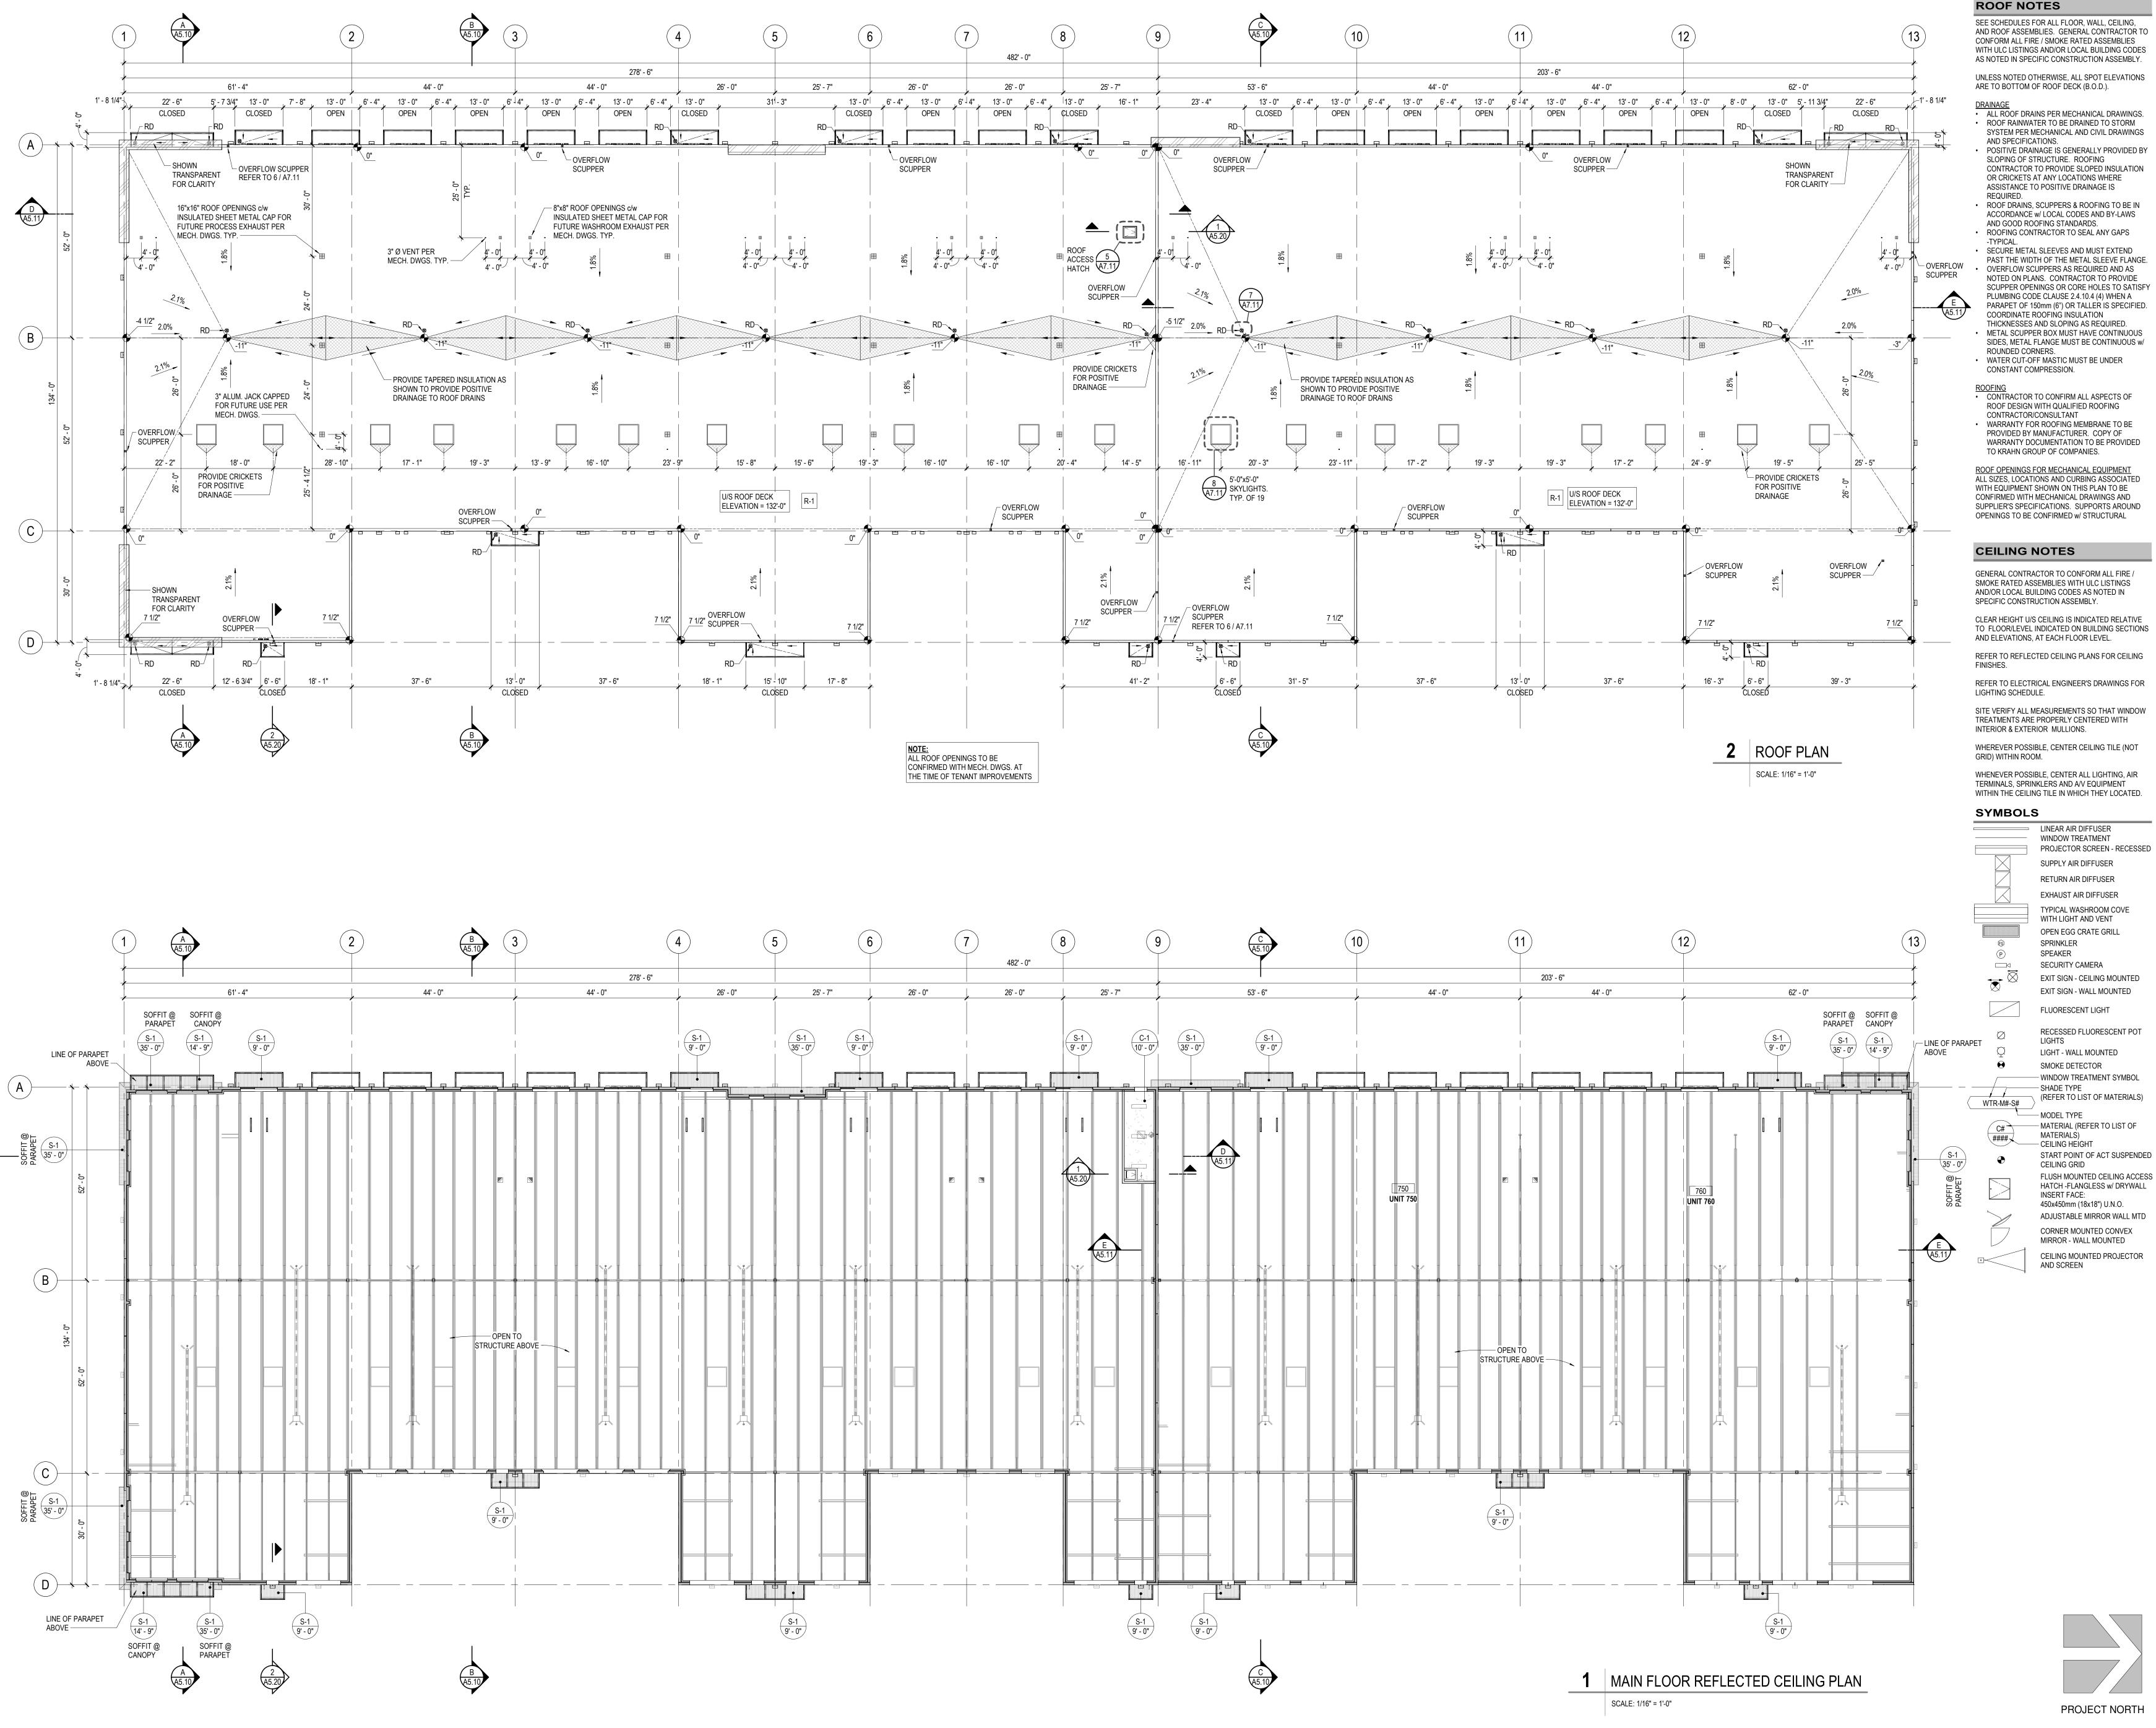

ABBOTSFORD OFFICE #400 - 34077 GLADYS AVE ABBOTSFORD, BC V2S 2E8 T 604.853.8831 F 604.850.1580 WWW.KRAHN.COM



**EDMONTON** 

VANCOUVER

SYSTEM PER MECHANICAL AND CIVIL DRAWINGS

OR CRICKETS AT ANY LOCATIONS WHERE ROOF DRAINS, SCUPPERS & ROOFING TO BE IN

SECURE METAL SLEEVES AND MUST EXTEND PAST THE WIDTH OF THE METAL SLEEVE FLANGE.

SCUPPER OPENINGS OR CORE HOLES TO SATISFY PLUMBING CODE CLAUSE 2.4.10.4 (4) WHEN A PARAPET OF 150mm (6") OR TALLER IS SPECIFIED. THICKNESSES AND SLOPING AS REQUIRED.

ROOF DESIGN WITH QUALIFIED ROOFING WARRANTY FOR ROOFING MEMBRANE TO BE

GENERAL CONTRACTOR TO CONFORM ALL FIRE / SMOKE RATED ASSEMBLIES WITH ULC LISTINGS AND/OR LOCAL BUILDING CODES AS NOTED IN

CLEAR HEIGHT U/S CEILING IS INDICATED RELATIVE TO FLOOR/LEVEL INDICATED ON BUILDING SECTIONS

REFER TO ELECTRICAL ENGINEER'S DRAWINGS FOR

WHEREVER POSSIBLE, CENTER CEILING TILE (NOT

WHENEVER POSSIBLE, CENTER ALL LIGHTING, AIR TERMINALS, SPRINKLERS AND A/V EQUIPMENT

PROJECTOR SCREEN - RECESSED

TYPICAL WASHROOM COVE

EXIT SIGN - CEILING MOUNTED

RECESSED FLUORESCENT POT

WINDOW TREATMENT SYMBOL

1 2025/01/17 ISSUED FOR DEVELOPMENT PERMIT NO. DATE Y/M/D DESCRIPTION

ABBOTSFORD • EDMONTON • VANCOUVER • TORONTO

This drawing has been prepared solely for the use of ARGUS PROPERTIES LTD. and there are no representations of any kind made by KP Architecture Ltd. to any party with whom KP

Architecture Ltd. has not entered into a contract. This drawing shall not be used for construction purposes until it is issued

for the purpose.

PROJECT NAME

BEAVER LAKE INDUSTRIAL - BUILDING 7

PROJECT ADDRESS 334 BEAVER LAKE ROAD KELOWNA, BC V4V 1S7

DRAWING TITLE **ROOF PLAN & REFLECTED CEILING PLAN** 


As indicated BSS DRAWN REVIEWED PROJECT NO.


DRAWING NO.


A2.11





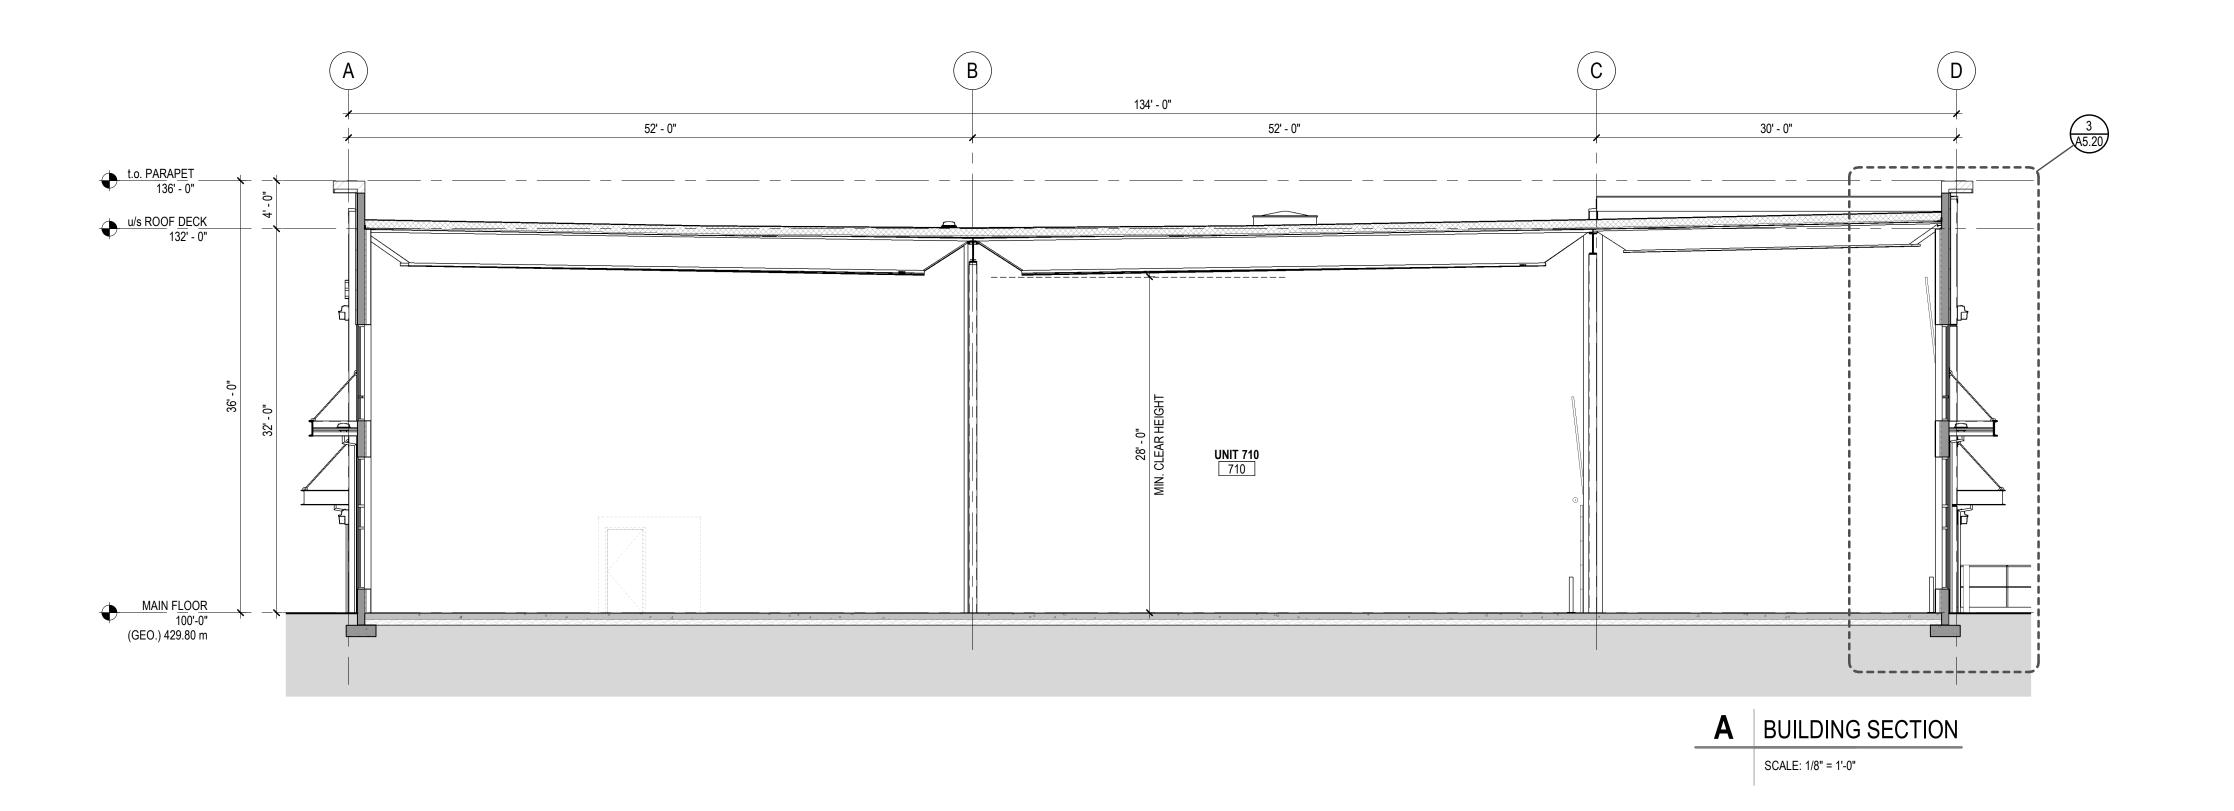

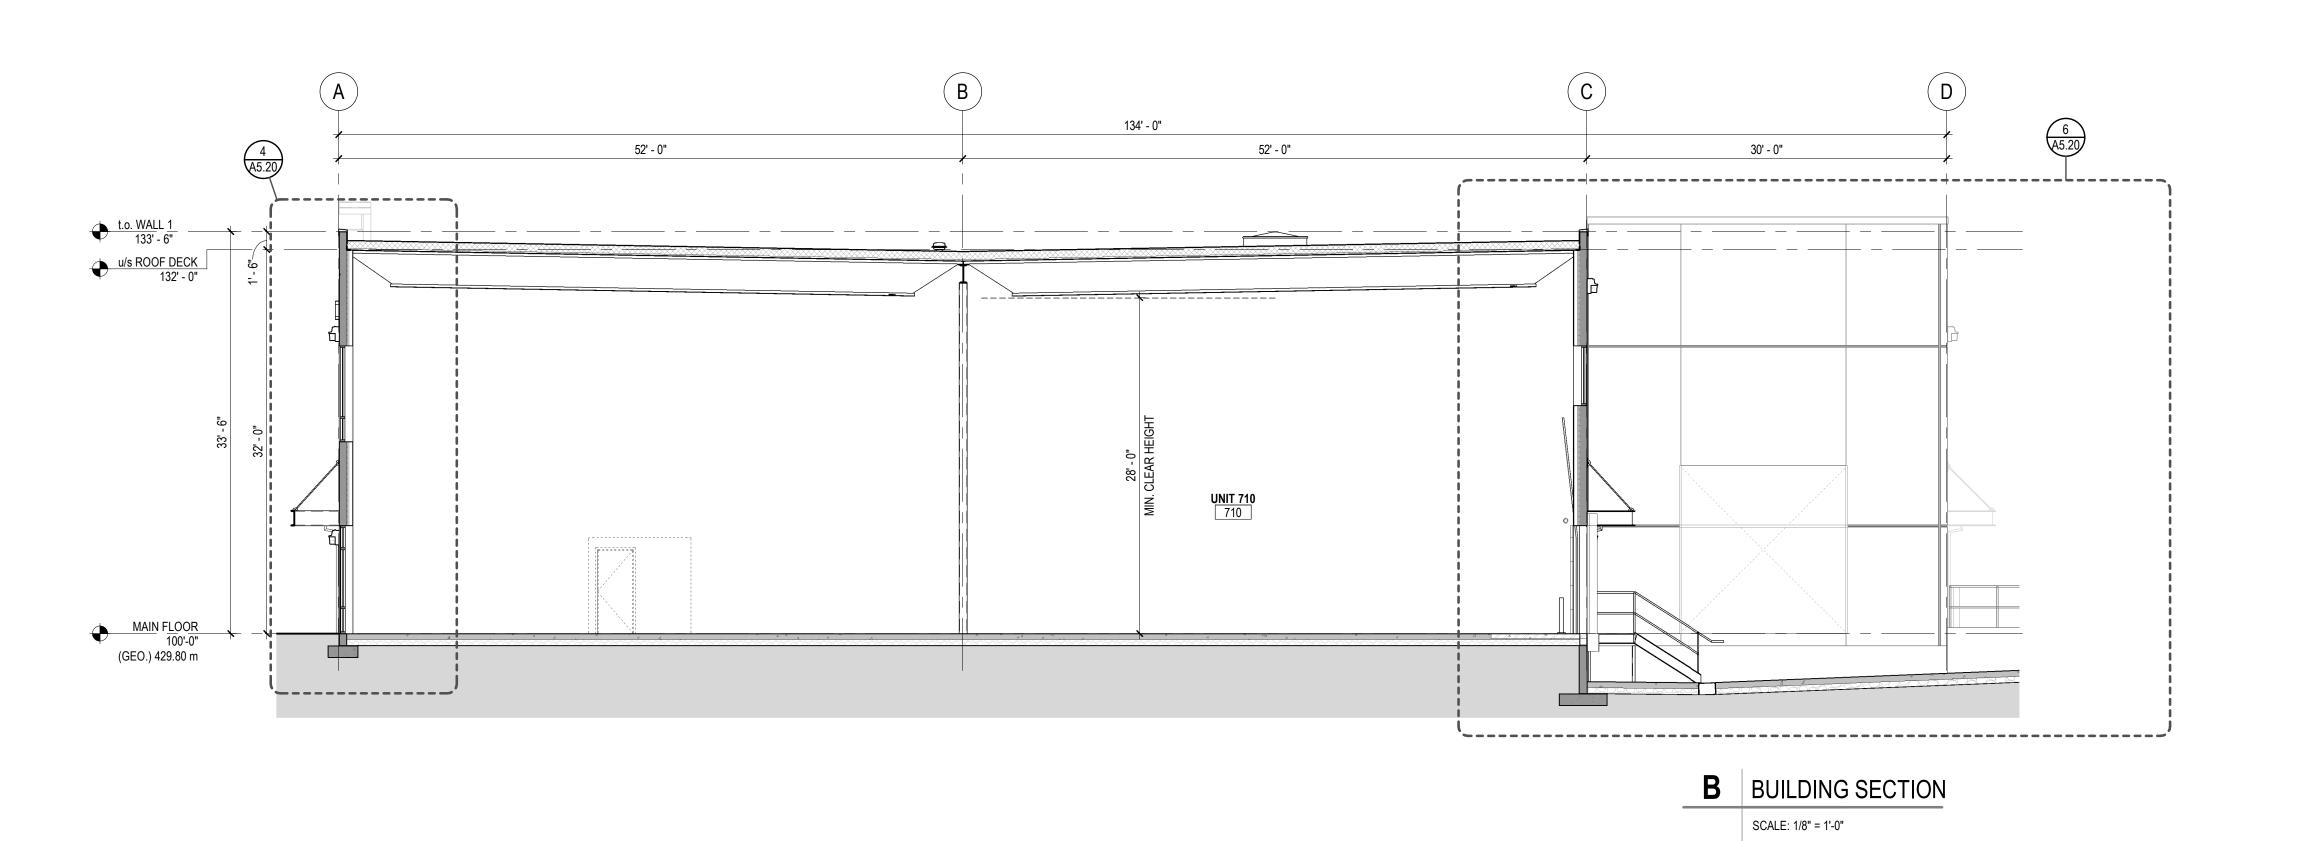

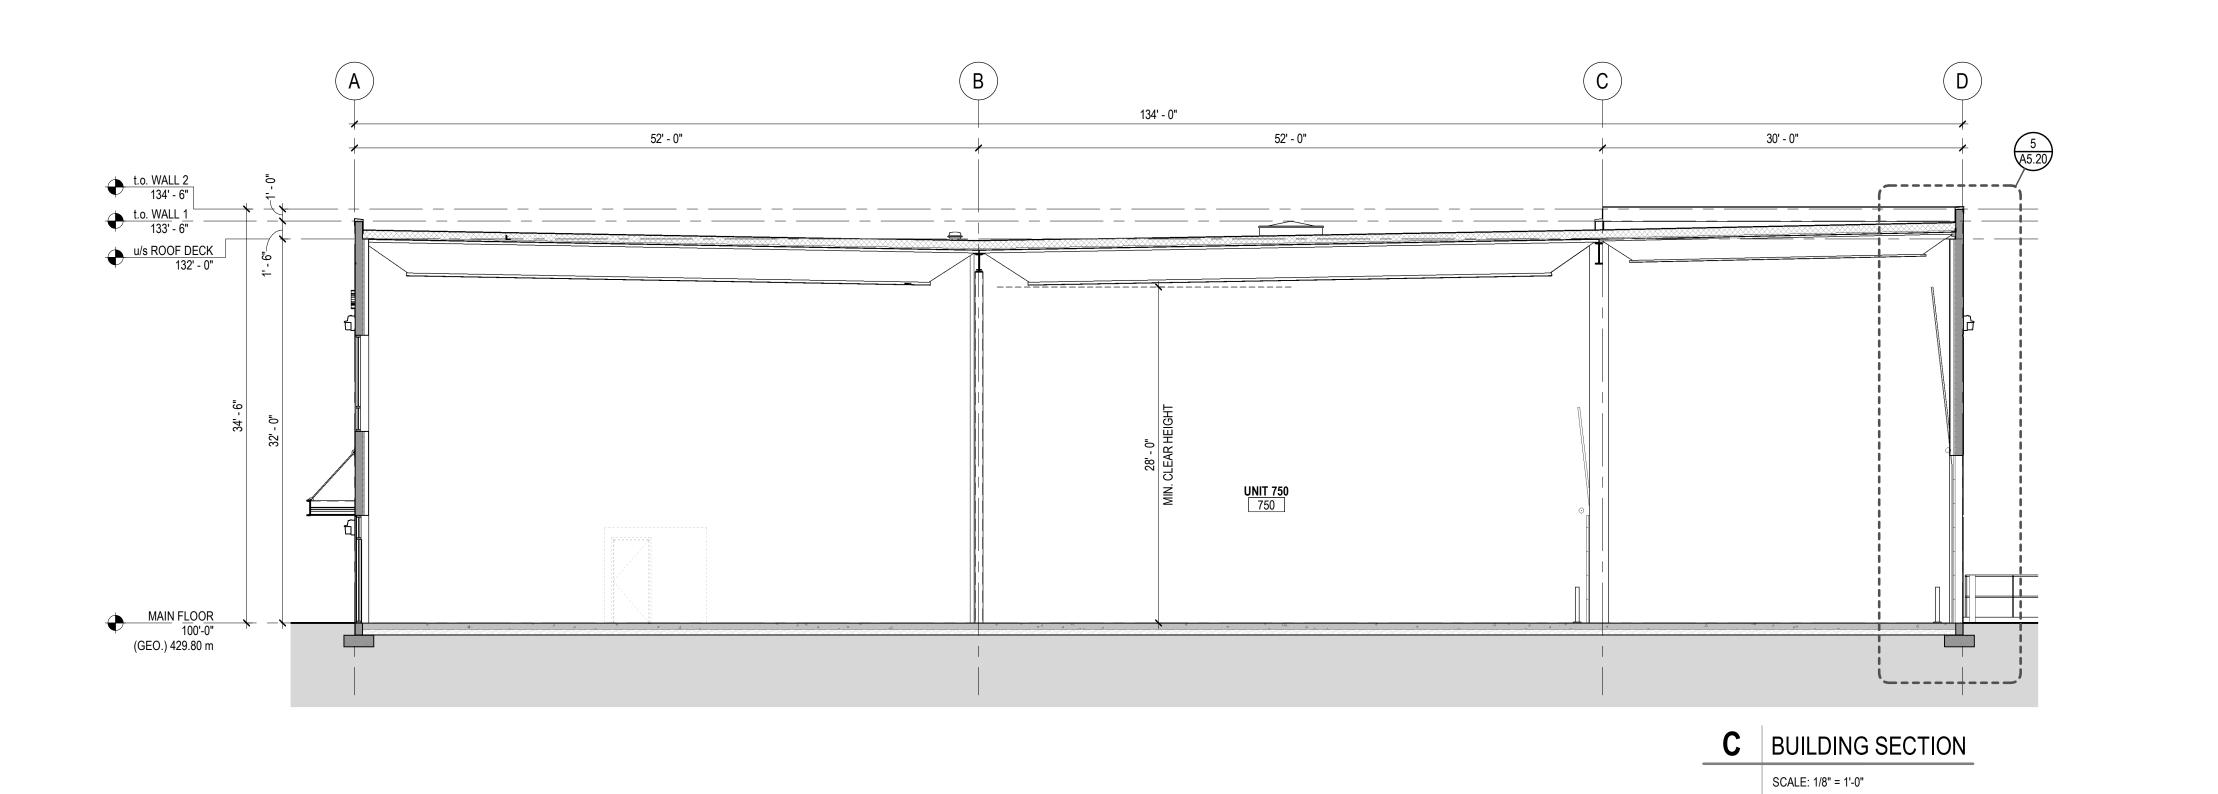


FIRE RATING •••• 0 HR F.S.R 45 MIN F.R.R.

**EDMONTON** 

1 HR F.R.R. 1.5 HR F.R.R.





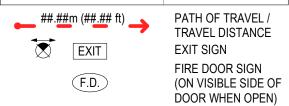

WALL CONSTRUCTION

ALL FIRE-RATED WALLS MUST BE CONSTRUCTED TO u/s STRUCTURE ABOVE. ALL SOUND ATTENUATION WALLS TO BE CONSTRUCTED TO u/s STRUCTURE ABOVE. ALL WALLS, NOT NOTED ABOVE, TO CONTINUE TO 1'-0" ABOVE CEILING.

#### **WET WALLS**

JANITOR ROOM, CHANGE ROOMS, LOCKER ROOMS AND WASHROOMS - REPLACE GYPSUM BOARD w/ GREEN BOARD at ALL WET WALLS.



shall not be used for construction purposes until it is issued for the purpose.

1 2025/01/17 ISSUED FOR DEVELOPMENT PERMIT NO. DATE Y/M/D DESCRIPTION


BEAVER LAKE INDUSTRIAL - BUILDING 7

PROJECT ADDRESS 334 BEAVER LAKE ROAD KELOWNA, BC V4V 1S7

DRAWING TITLE **BUILDING SECTIONS** 

SCALE	As indicated
DRAWN	BSS
REVIEWED	
PROJECT NO.	230457-A

**A2.10** 

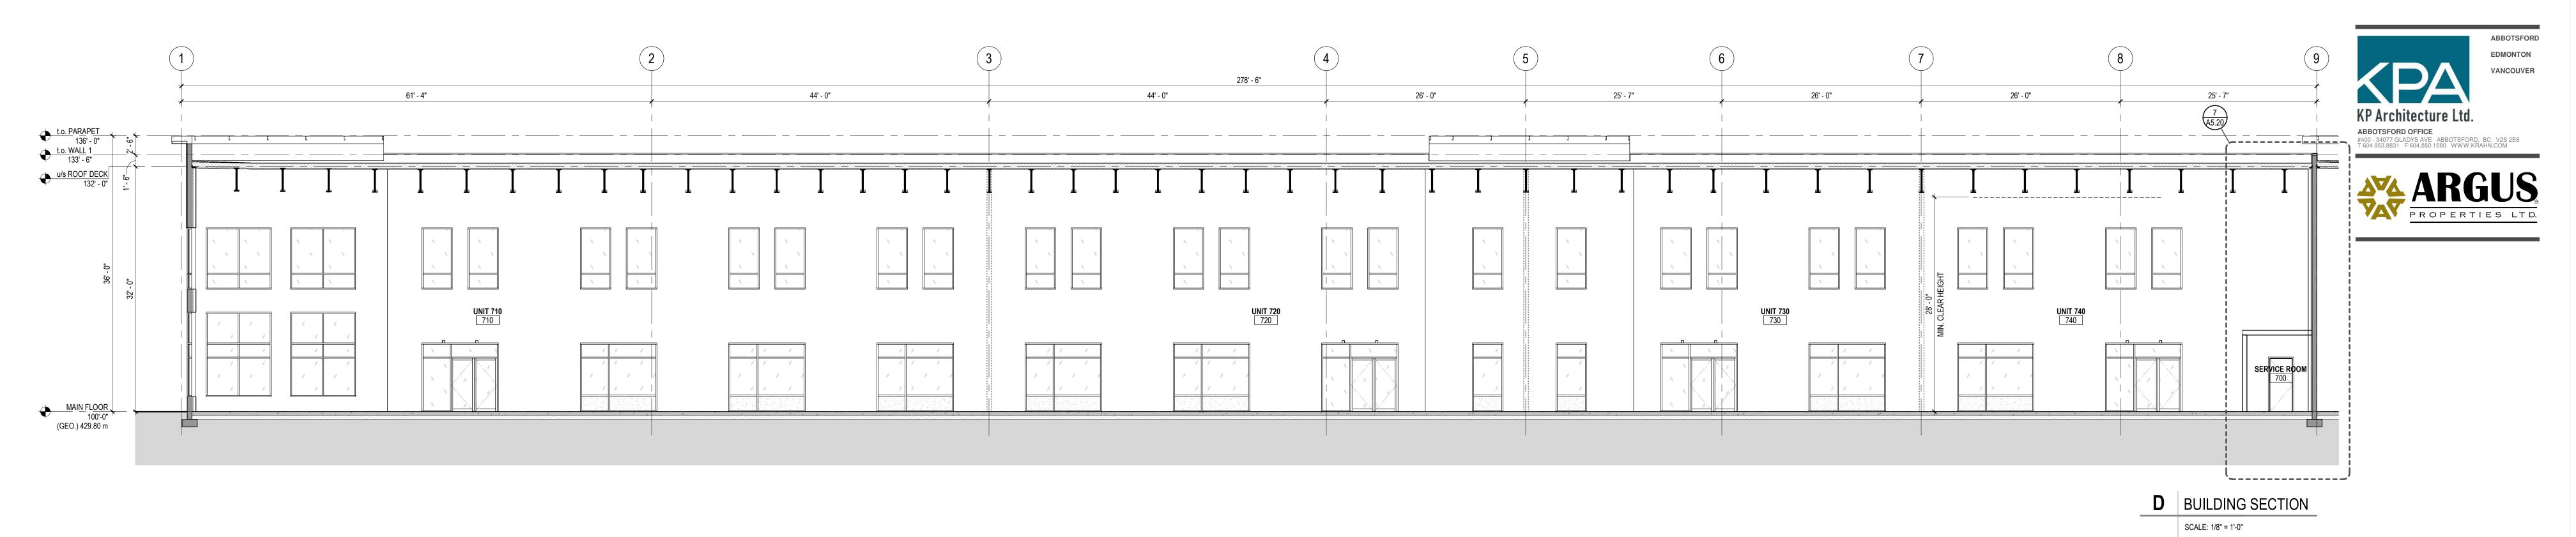

203' - 6" 53' - 6" 62' - 0" 44' - 0" 44' - 0" t.o. WALL 2
134' - 6"
t.o. WALL 1
133' - 6"
u/s ROOF DECK
132' - 0" **UNIT 750** 750 (GEO.) 429.80 m '----'

ABBOTSFORD • EDMONTON • VANCOUVER • TORONTO This drawing has been prepared solely for the use of ARGUS PROPERTIES LTD. and there are no representations of any

kind made by KP Architecture Ltd. to any party with whom KP

Architecture Ltd. has not entered into a contract. This drawing shall not be used for construction purposes until it is issued for the purpose.

1 2025/01/17 ISSUED FOR DEVELOPMENT PERMIT NO. DATE Y/M/D DESCRIPTION ISSUES AND REVISIONS

BEAVER LAKE INDUSTRIAL

FIRE RATING •••• 0 HR F.S.R 45 MIN F.R.R. 1 HR F.R.R. 1.5 HR F.R.R. 2 HR F.R.R. 3 HR F.R.R. 4 HR F.R.R. ##.##m (##.## ft) PATH OF TRAVEL / TRAVEL DISTANCE

EXIT

u/s STRUCTURE ABOVE.

**E** BUILDING SECTION

SCALE: 1/8" = 1'-0"

KELOWNA, BC V4V 1S7 EXIT SIGN DRAWING TITLE FIRE DOOR SIGN (ON VISIBLE SIDE OF DOOR WHEN OPEN)

**BUILDING SECTIONS** WALL CONSTRUCTION ALL FIRE-RATED WALLS MUST BE CONSTRUCTED TO

SCALE DRAWN ALL WALLS, NOT NOTED ABOVE, TO CONTINUE TO REVIEWED PROJECT NO. DRAWING NO.

PROJECT NAME

- BUILDING 7

PROJECT ADDRESS


334 BEAVER LAKE ROAD

JANITOR ROOM, CHANGE ROOMS, LOCKER ROOMS


1'-0" ABOVE CEILING. **WET WALLS** AND WASHROOMS - REPLACE GYPSUM BOARD w/ GREEN BOARD at ALL WET WALLS.

ALL SOUND ATTENUATION WALLS TO BE CONSTRUCTED TO u/s STRUCTURE ABOVE.

As indicated BSS 230457-A

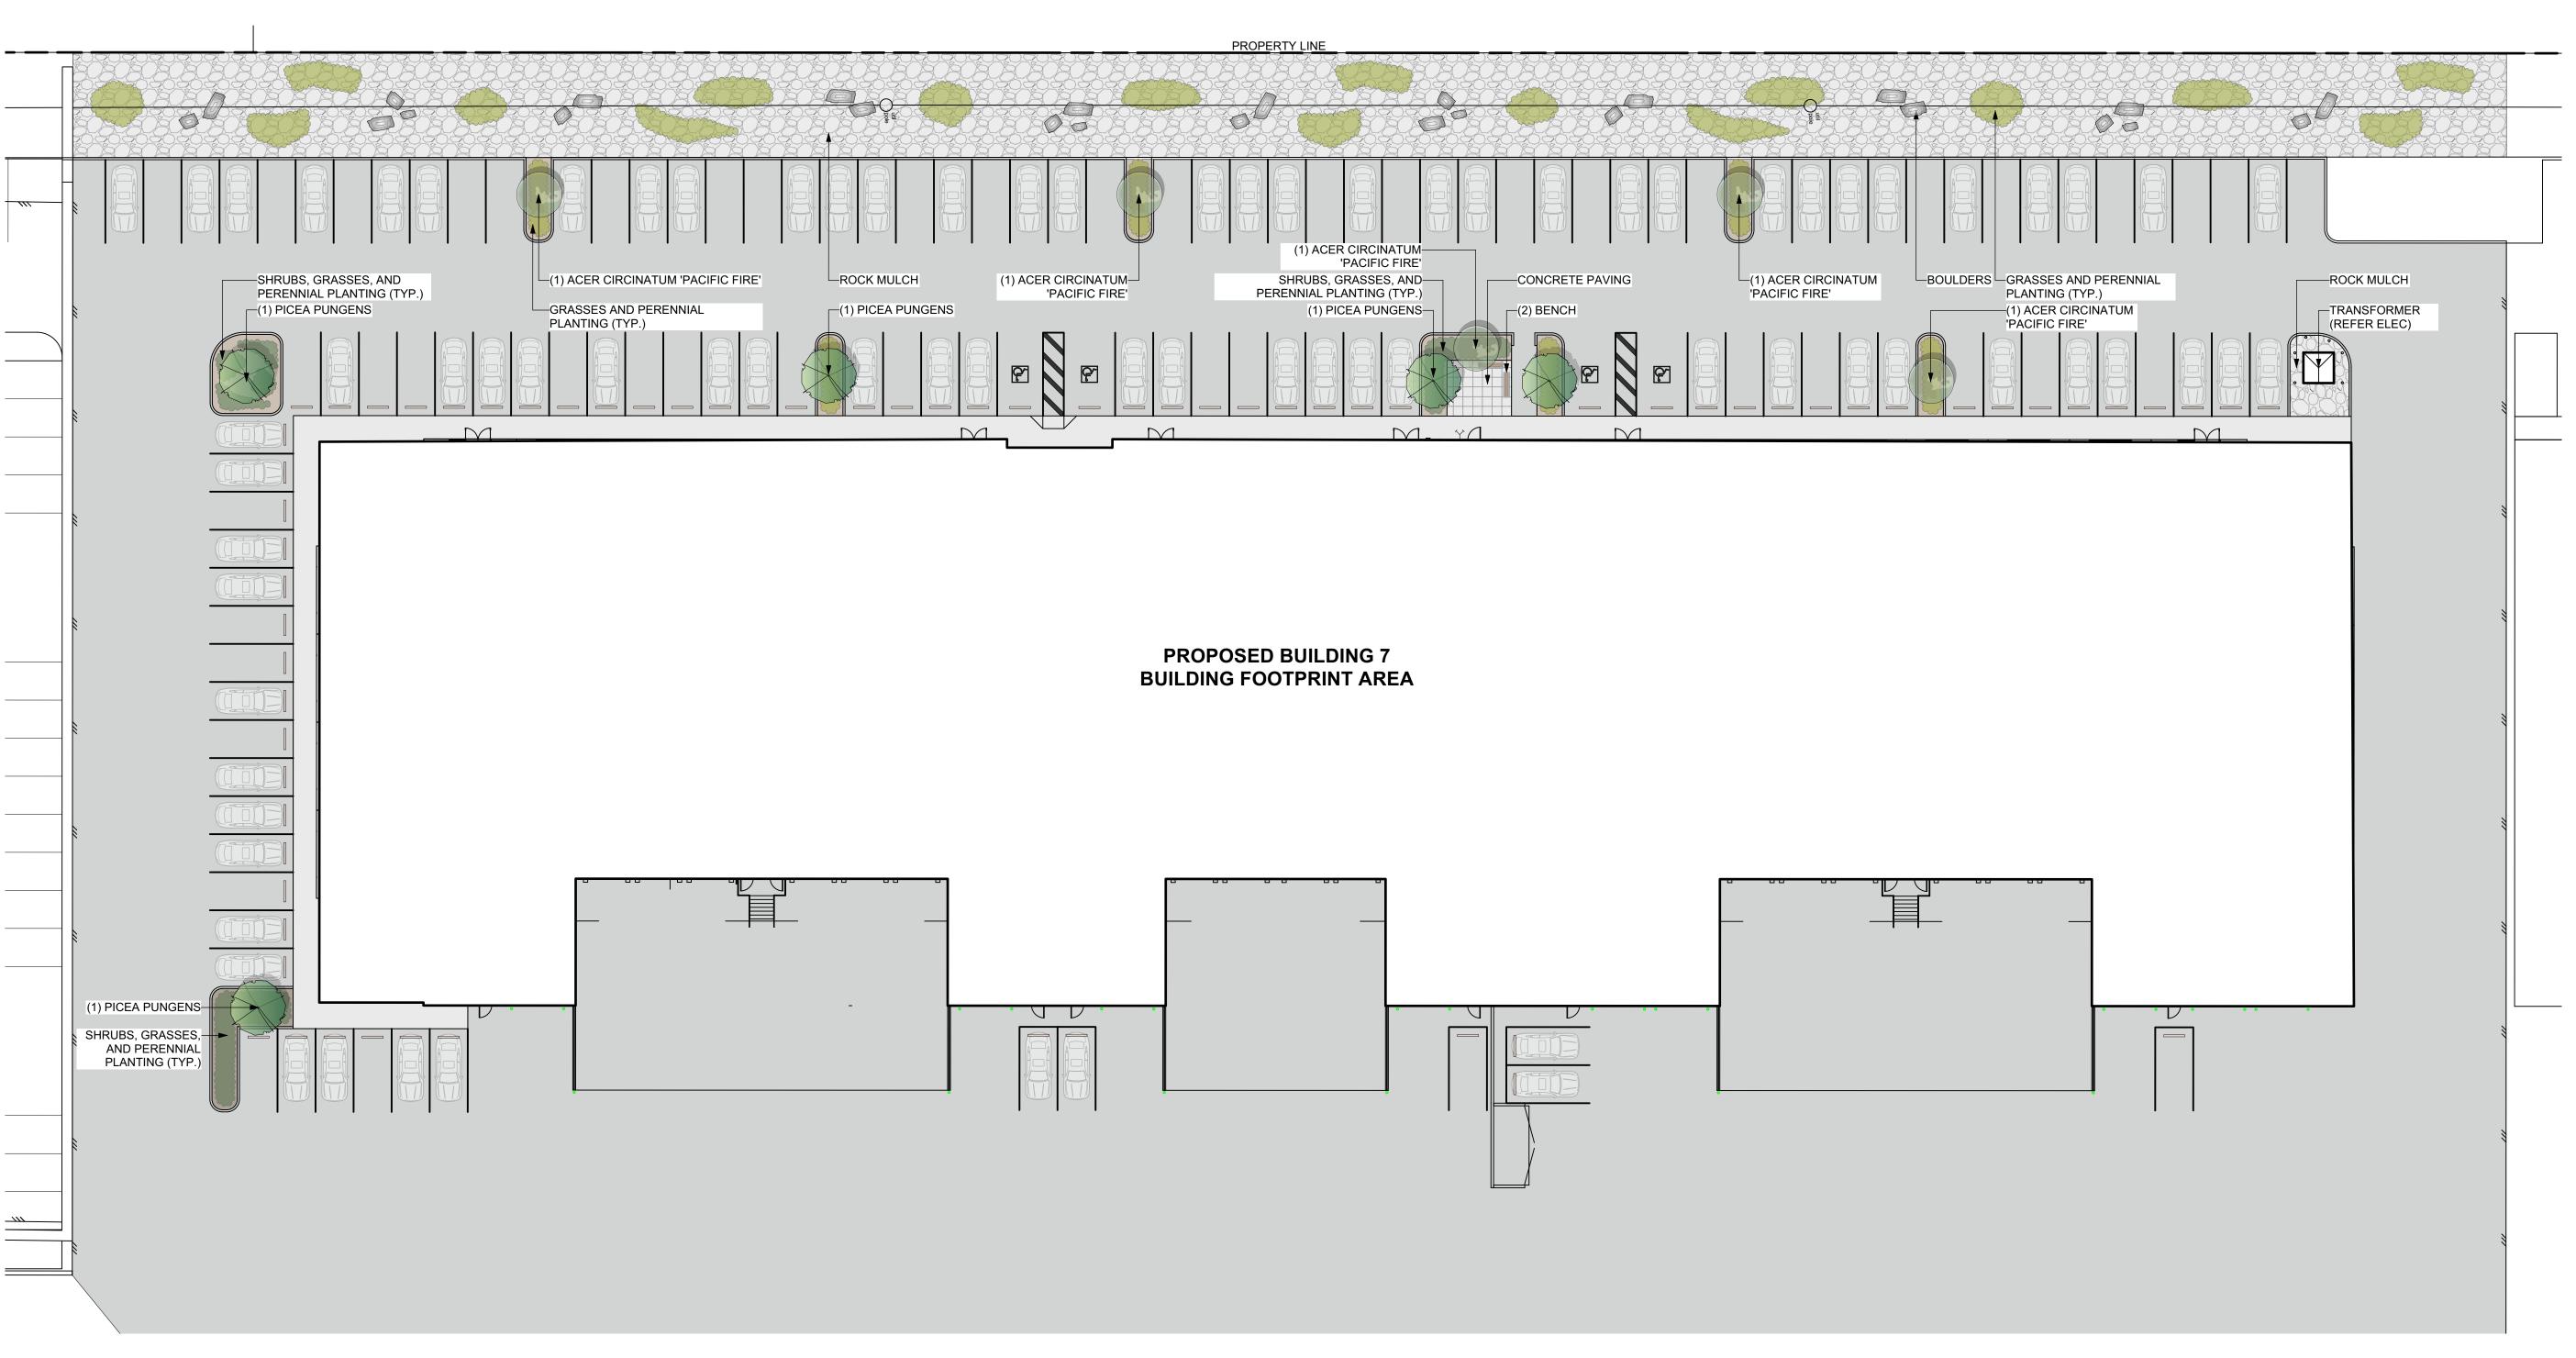



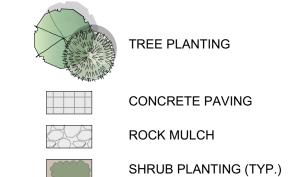

GRASSES AND PERENNIAL PLANTING (TYP.)


BENCH

### **PLANT LIST**

QTY	BOTANICAL NAME	COMMON NAME	SIZE	ROO
	TREES			
5	Acer circinatum 'Pacific Fire'	Pacific Fire Vine Maple	5cm Cal	В&Е
5	Picea pungens	Blue Spruce	5cm Cal	В&Е
	SHRUBS			
	Artemisia pontica	Roman Wormwood	#02	Potte
	Physocarpus opulifolius 'Jefam'	Amber Jubilee Ninebark	#02	Potte
	Rosa rugosa 'Alba'	Rugosa Rose	#02	Potte
	Potentilla fruticosa	Shrubby Cinquefoil	#02	Potte
	Taxus x media 'Hillii'	Hill's Yew	#02	Potte
	Rhus aromatica 'Gro-Low'	Fragrant Sumc	#02	Potte
	Yucca filamentosa	Adam's Needle	#02	Potte
	GRASSES AND PERENNIALS			
	Festuca glauca 'Elijah Blue'	Blue Fescue	#01	Potte
	Helictrotrichon sempervirens	Blue Oat Grass	#01	Potte
	Heuchera	Coral Bells	#01	Potte
	Sedum spectabile	Stonecrop	#01	Potte





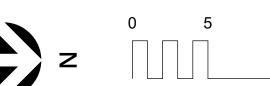



COPYRIGHTS:

Copyright Reserved. This drawing is the property of CTQ Consultants Limited and shall not be reproduced, resold, or tendered without permission.

1. PLANT MATERIAL AND CONSTRUCTION METHODS SHALL MEET OR EXCEED CANADIAN LANDSCAPE STANDARDS.

2. ALL SOFT LANDSCAPE AREAS SHALL BE WATERED BY A FULLY AUTOMATIC TIMED UNDERGROUND IRRIGATION

3. TREE AND SHRUB BEDS TO BE DRESSED IN A MINIMUM 75mm NATURAL WOOD MULCH AS SHOWN IN PLANS. DO NOT PLACE WEED MAT UNDERNEATH TREE AND SHRUB


4. SHRUB BEDS TO RECEIVE A MINIMUM 300mm DEPTH GROWING MEDIUM PLACEMENT. TREES TO RECIEVE A MINIMUM 1.0M DEPTH GROWING MEDIUM PLACEMENT.

5. TURF AREA FROM SOD SHALL BE NO.1 GRADE GROWN FROM CERTIFIED SEED OF IMPROVED CULTIVARS REGISTERED FOR SALE IN B.C. AND SHALL BE TOLERANT OF DROUGHT CONDITIONS. A MINIMUM OF 150mm DEPTH OF GROWING MEDIUM IS REQUIRED BENEATH TURF AREAS. TURF AREAS SHALL MEET EXISTING GRADES AND HARD SURFACES FLUSH.

6. SITE GRADING AND DRAINAGE WILL ENSURE THAT ALL STRUCTURES HAVE POSITIVE DRAINAGE AND THAT NO WATER OR LOOSE IMPEDIMENTS WILL BE DISCHARGED FROM THE LOT ONTO ADJACENT PUBLIC, COMMON, OR PRIVATE PROPERTIES.

SEAL



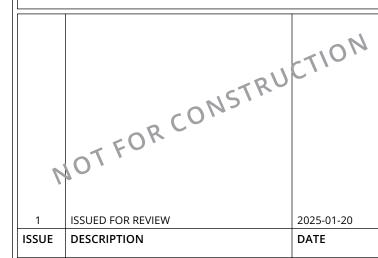

ARGUS PROPERTIES LTD.

PROJECT NAME:

**BUILDING 7** 334 BEAVER LAKE ROAD

DRAWING TITLE:


SCALE:

LANDSCAPE SITE PLAN

DRAWING NO.: CHECKED: PROJECT NO.: 25003-100

1:000

LDP 1

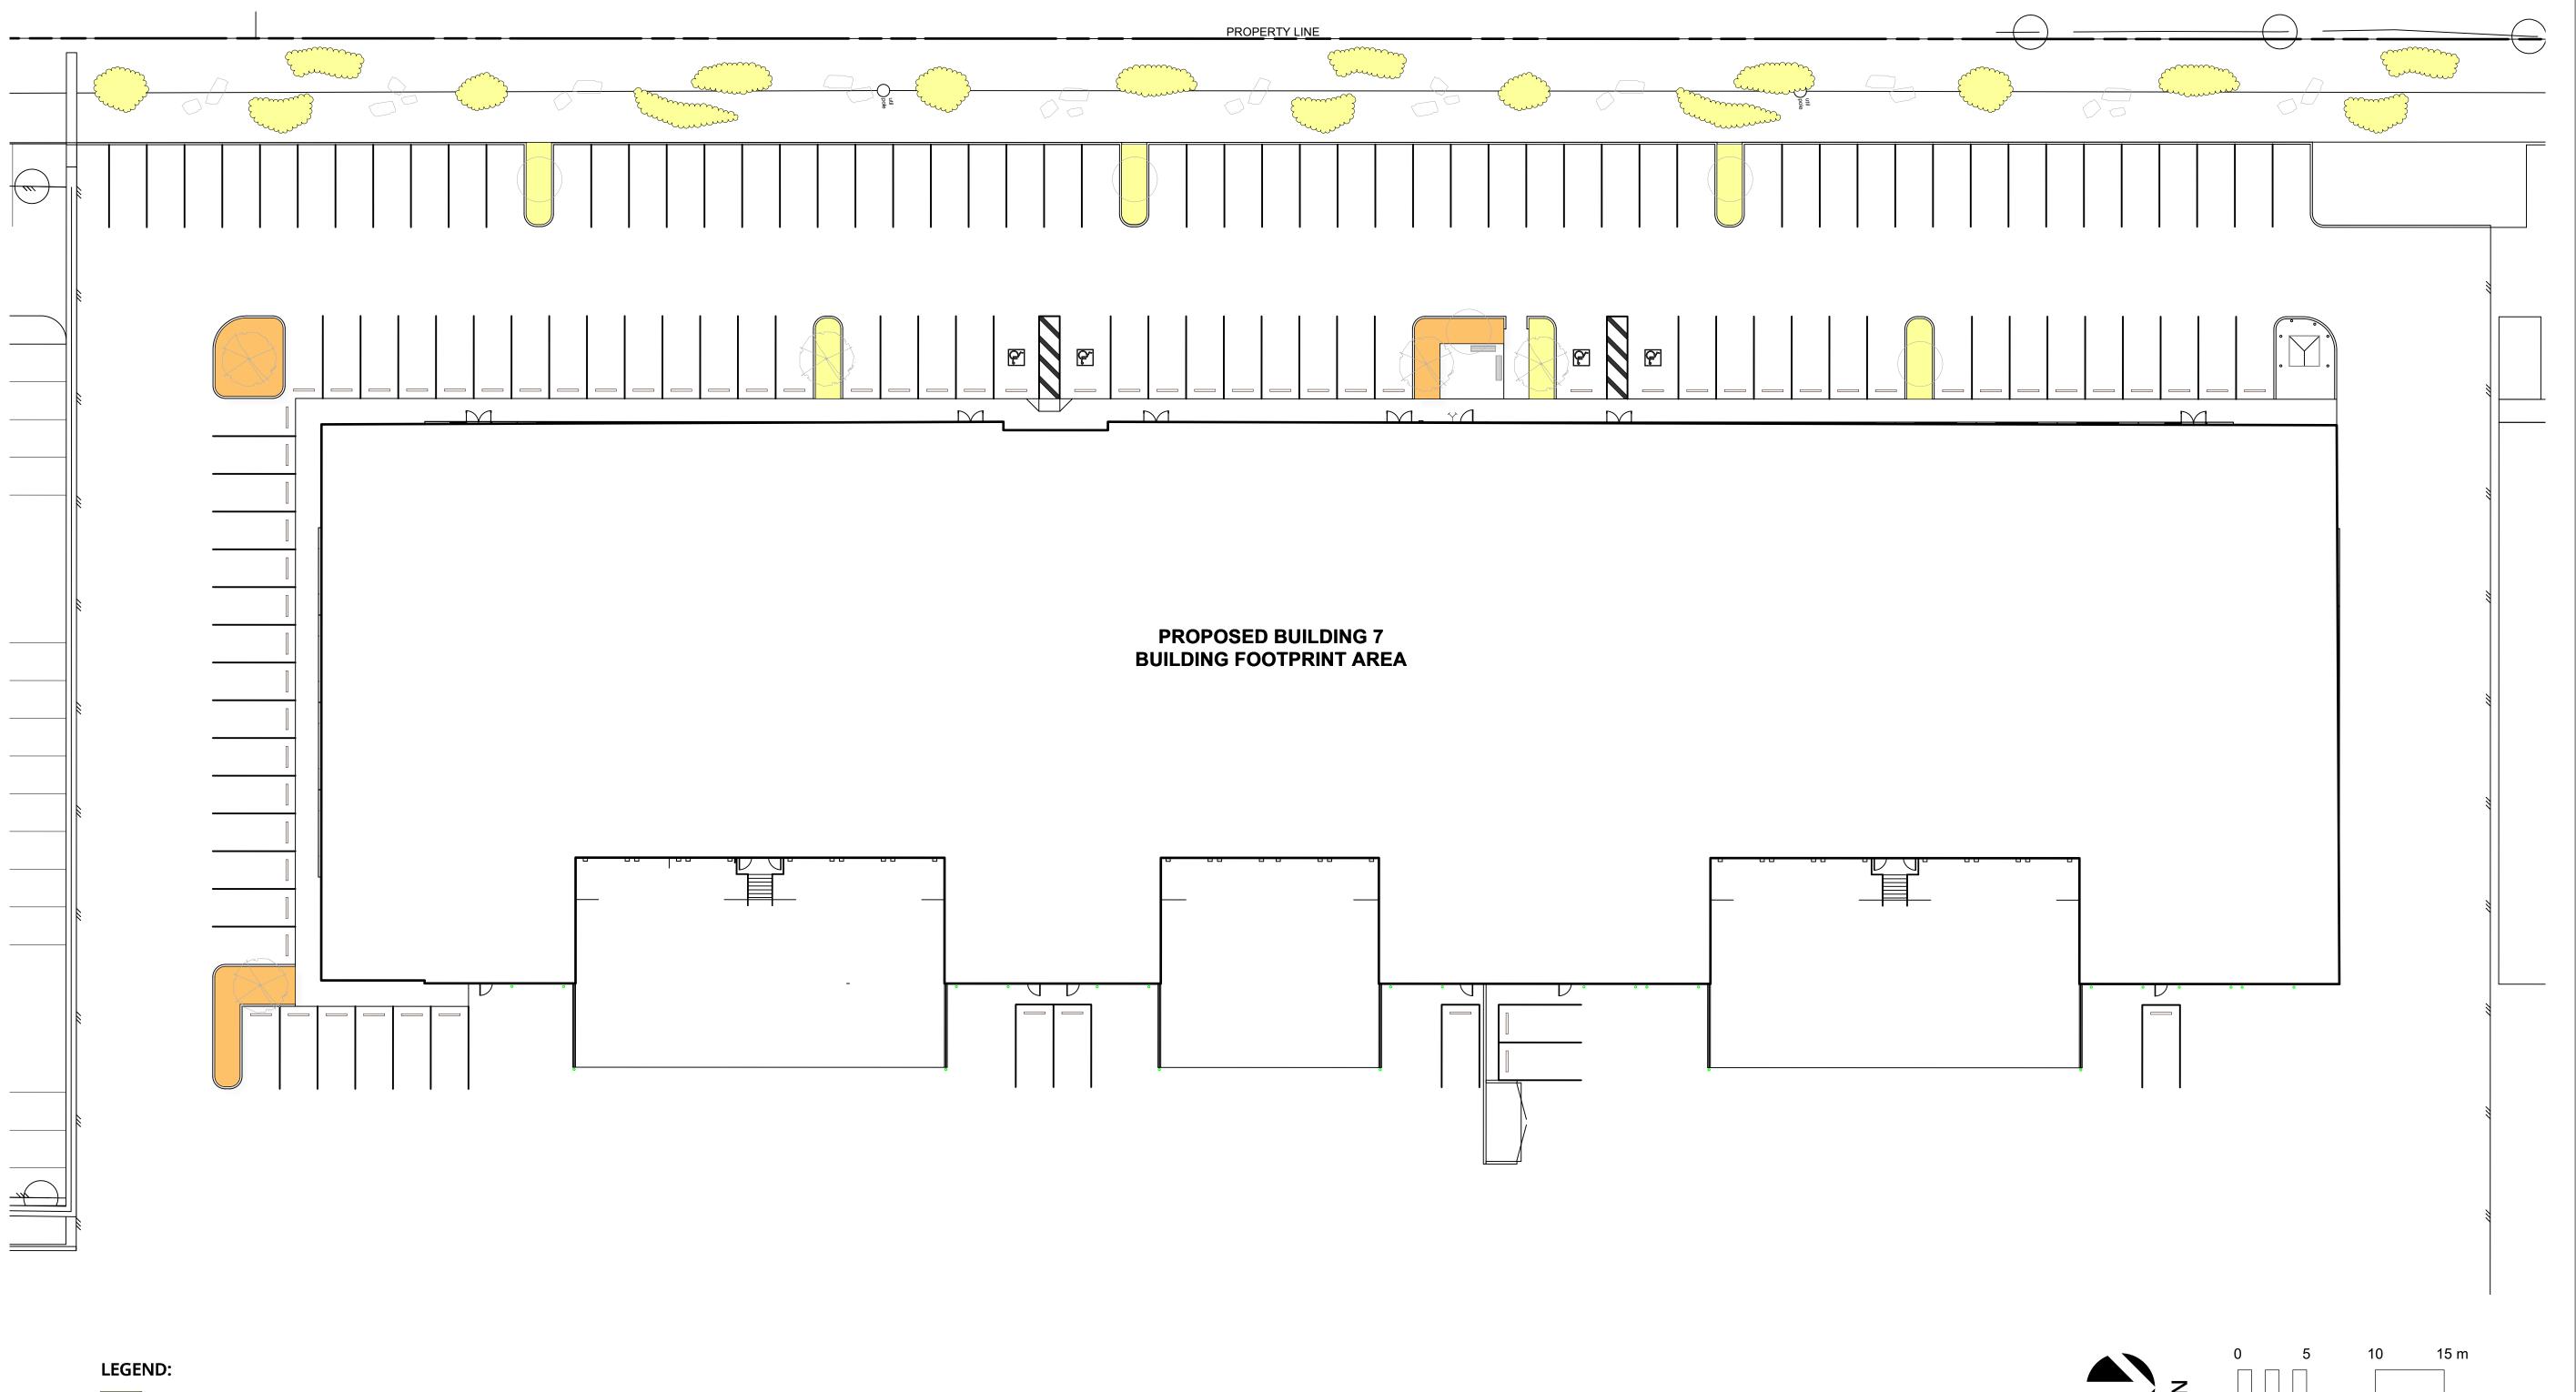

LOW WATER REQUIREMENTS - GRASSES / PERENNIALS

MEDIUM WATER REQUIREMENTS - SHRUBS

### WATER CONSERVATION CALCULATIONS

= 196 sq.m. TOTAL LANDSCAPE AREA LANDSCAPE MAXIMUM WATER BUDGET (WB) = 118 cu.m./yr ESTIMATED LANDSCAPE WATER USE (WU) = 55 cu.m./yr WATER BALANCE = 63 cu.m./yr

\*REFER ATTACHED IRRIGATION APPLICATION FOR DETAILED CALCULATIONS\*



COPYRIGHTS:

Copyright Reserved. This drawing is the property of CTQ Consultants Limited and shall not be reproduced, resold, or tendered without permission.

1. IRRIGATION PRODUCTS AND INSTALLATION METHODS SHALL MEET OR EXCEED THE REQUIREMENTS OF THE WATER USE REGULATION BYLAW NO. 10480 AND THE SUPPLEMENTARY SPECIFICATIONS IN THE CITY OF KELOWNA BYLAW 7900 (PART 6, SCHEDULE 5).

2. THE IRRIGATION SYSTEM SHALL MEET THE REQUIREMENTS, REGULATIONS, AND BYLAWS OF THE WATER PURVEYOR.

3. THE IRRIGATION SYSTEM SHALL BE EQUIPPED WITH AN APPROVED BACKFLOW PREVENTION DEVICE, WATER METER, AND SHUT OFF VALVE LOCATED OUTSIDE THE BUILDING ACCESSIBLE TO THE CITY.

4. AN APPROVED SMART CONTROLLER SHALL BE INSTALLED. THE IRRIGATION SCHEDULING TIMES SHALL UTILIZE A MAXIMUM ET VALUE OF 7" / MONTH (KELOWNA JULY ET), TAKING INTO CONSIDERATION SOIL TYPE, SLOPE, AND MICROCLIMATE.


5. DRIP LINE AND EMITTERS SHALL INCORPORATE TECHNOLOGY TO LIMIT ROOT INTRUSION.

6. IRRIGATION SLEEVES SHALL BE INSTALLED TO ROUTE IRRIGATION LINES UNDER HARD SURFACES AND FEATURES.

7. IRRIGATION PIPE SHALL BE SIZED TO ALLOW FOR A MAXIMUM FLOW OF 1.5m /SEC.

8. A FLOW SENSOR AND MASTER VALVE SHALL BE CONNECTED TO THE CONTROLLER AND PROGRAMMED TO STOP FLOW TO THE SYSTEM IN CASE OF AN IRRIGATION WATER LEAK.



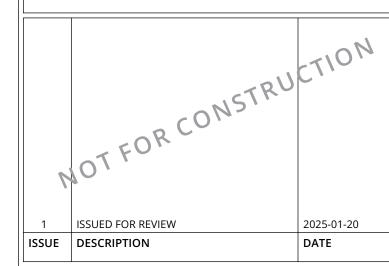

ARGUS PROPERTIES LTD.

PROJECT NAME:

**BUILDING 7** 334 BEAVER LAKE ROAD

DRAWING TITLE:

SCALE:

1:000

WATER CONSERVATION PLAN

DRAWING NO.: CHECKED: LDP 2 PROJECT NO.: 25003-100